

TOWN OF CUTLER BAY

CUTLER RIDGE PINES ROADWAY AND DRAINAGE IMPROVEMENTS

COMMUNITY OFFICIALS

TIM MEERBOTT, MAYOR

MICHAEL P. CALLAHAN, VICE MAYOR

ROBERT "B.J." DUNCAN, COUNCIL MEMBER SEAT 1

SUZY LORD, COUNCIL MEMBER SEAT 2

RICHARD RAMIREZ, COUNCIL MEMBER SEAT 3

INDEX OF SHEETS

SHEET No. SHEET DESCRIPTION

C-1 COVER SHEET

C-2 PROJECT LAYOUT

C-3 TO C-4 GENERAL NOTES

C-5 LEGEND AND ABBREVIATIONS

C-6 PAY ITEMS NOTES


C-7 SUMMARY OF QUANTITIES

C-8 TO C-18 ROADWAY PLAN

C-19 TO C-32 DRAINAGE STRUCTURES
C-33 TO C-41 MISCELLANEOUS DETAILS

C-42 TO C-46 PAVEMENT MARKING AND SIGNAGE PLANS

C-47 STORMWATER POLLUTION PREVENTION PLAN NOTES & DETAILS

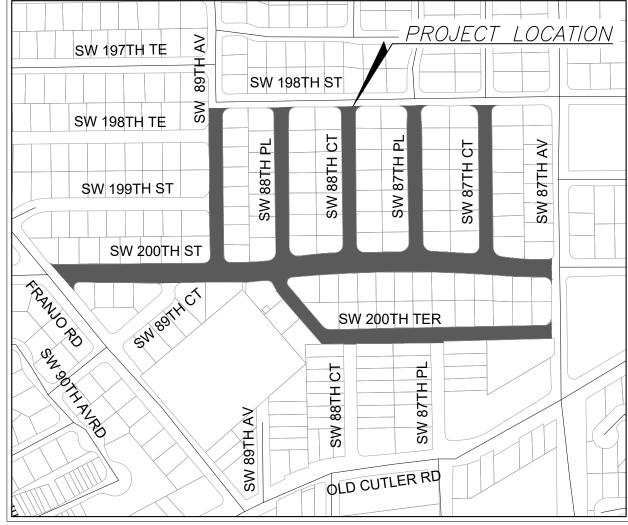



NEW PORT RICHEY

Project Location

THIS ITEM HAS BEEN DIGITALLY SIGNED AND SEALED BY: IGNACIO SERRALTA, P.E. ON THE DATE ADJACENT TO THE SEAL. PRINTED COPIES OF THIS DOCUMENT ARE NOT CONSIDERED SIGNED AND SEALED AND THE SIGNATURE MUST BE VERIFIED ON ANY ELECTRONIC COPIES.

FT PIERCE

SECTION 4 & 9 - TOWNSHIP 56 SOUTH - RANGE 40 EAST



- THE SCALE OF THESES PLANS MAY HAVE CHANGE DUE TO REPRODUCTION.
- ALL WORK SHALL BE PERFORMED WITHIN THE LIMITS OF EXISTING STATE / LOCAL RIGHT OF WAY,
 AND ALL IMPROVEMENTS SHALL BE CONSTRUCTED AND INSTALL WITHIN SAID LIMITS
- AL ELEVATIONS REFER TO THE NATIONAL GEODETIC VERTICAL DATUM OF 1929 (NGVD-29)

ENGINEER'S CERTIFICATION:

• THIS PLAN WAS PREPARED UNDER MY DIRECTION AND TO THE BEST OF MY KNOWLEDGE AND BELIEF, COMPLIES WITH THE INTENT OF THE MANUAL OF UNIFORM STANDARDS FOR DESIGN, CONSTRUCTION AND MAINTENANCE OF STREETS AND HIGHWAYS AS ADOPTED BY THE STATE OF FLORIDA LEGISLATURE.

GOVERNING STANDARDS AND SPECIFICATIONS:

- MIAMI DADE COUNTY DEPARTMENT OF TRANSPORTATION AND PUBLIC WORKS ENGINEERING STANDARDS FOR DESIGN AND CONSTRUCTION.
- FLORIDA DEPARTMENT OF TRANSPORTATION, STANDARDS PLANS FY 2023-24, AND STANDARD SPECIFICATIONS FOR ROAD AND BRIDGE CONSTRUCTION DATED JULY 06-21-2023 (LAST UPDATED), MANUAL OF UNIFORM CONTROL DEVICE FOR STREETS AND HIGHWAYS, 2009 MUTCD WITH REVISIONS 1, 2, AND 3, JULY 2022, AS AMENDED BY CONTRACT DOCUMENTS.

PREPARED BY:




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COVER SHEET			
DA	DATE:9/25/2023 SHEET: C-1		



- 2 ALL ELEVATIONS REFER TO THE NATIONAL GEODETIC VERTICAL DATUM OF 1929 (NGVD-29).
- FLOOD CRITERIA ELEVATION IS 9.56 NGVD-29 (AVERAGE) FEET BASED ON MIAMI DADE COUNTY FLOOD CRITERIA MAPS. OCTOBER WATER LEVEL 2.50 NGVD-29 https://gis-mdc.opendata.arcgis.com/datasets/county-flood-criteria-2022/explore?location=25.5824 28%2C-80.334180%2C17.79&style=ELEV
- 4 IN ACCORDANCE WITH THE FEDERAL EMERGENCY MANAGEMENT AGENCY (FEMA) FLOOD INSURANCE RATE MAP (FIRM) COMMUNITY PANEL No. 120218, MAP No. 0604, SUFFIX L, THIS PROJECT IS LOCATED IN FLOOD ZONE "AH" EL. 7.00 https://gis-mdc.opendata.arcgis.com/apps/miami-dade-preliminary-flood-zones-viewer/explore
- ALL PUBLIC LAND CORNERS AND MONUMENTS WITHIN THE LIMITS OF CONSTRUCTION ARE TO BE PROTECTED BY THE CONTRACTOR AS FOLLOWS: CORNERS AND MONUMENTS IN CONFLICT WITH THE WORK AND IN DANGER OF BEING DAMAGED, DESTROYED OR COVERED HAVE TO BE PROPERLY REFERENCED BY A PROFESSIONAL LAND SURVEYOR IN ACCORDANCE WITH THE MINIMUM TECHNICAL STANDARDS OF THE FLORIDA BOARD OF PROFESSIONAL LAND SURVEYORS PRIOR TO BEGINNING WORK AT THAT SITE. THE CONTRACTOR SHALL RETAIN THE LAND SURVEYOR OF REFERENCE, AND RESTORE UPON COMPLETION OF THE WORK, ALL SUCH CORNERS AND MONUMENTS AND SHALL FURNISH TO THE ENGINEER A SIGNED AND SEALED COPY OF THE LAND SURVEYOR'S REFERENCE DRAWING.
- ALL BENCH MARK MONUMENTS WITHIN THE LIMITS OF CONSTRUCTION SHALL BE PROTECTED AND REFERENCED BY THE CONTRACTOR IN THE SAME WAY AS PUBLIC LAND CORNERS EXCEPT THAT THE LAND SURVEYOR SHALL NOT BE REQUIRED TO RESTORE THE BENCH MARK UPON COMPLETION OF THE WORK. THE CONTRACTOR SHALL PROMPTLY TRANSMIT ALL DISPLACED OR DAMAGED N.G.V.D. DISCS TO THE ENGINEER, WHO WILL NOTIFY THE GEODETIC INFORMATION CENTER.
- ALL CONSTRUCTION ASSOCIATED WITH THIS PROJECT SHALL BE IN ACCORDANCE WITH APPLICABLE CODES & AUTHORITIES HAVING JURISDICTION, INCLUDING BUT NOT LIMITED TO THE TOWN OF CUTLER BAY PUBLIC WORKS DEPARTMENT, MIAMI-DADE DEPARTMENT OF TRANSPORTATION AND PUBLIC WORKS DEPARTMENT STANDARDS, THE FLORIDA DEPARTMENT OF TRANSPORTATION (FDOT), MIAMI-DADE COUNTY'S REGULATORY AND ECONOMIC RESOURCES (RER). ANY DISCREPANCY MUST BE IMMEDIATELY BROUGHT TO THE ATTENTION OF THE TOWN OF CUTLER BAY AND ENGINEER OF RECORD (EOR).
- CONTRACTOR WILL SECURE AND PAY ALL PERMIT FEES FOR THE WORK NECESSARY TO COMPLETE THIS PROJECT. CONTRACTOR SHALL COORDINATE EFFORTS WITHIN THE CITY'S PUBLIC WORKS
- CONTRACTOR SHALL USE A STREET SWEEPER (USING WATER OR OTHER EQUIPMENT) FOR CONTROLLING AND REMOVING DUST. APPROVAL OF THE USE OF SUCH EQUIPMENT IS CONTINGENT UPON ITS DEMONSTRATED ABILITY TO DO THE WORK. CLEANING AND SWEEPING IS TO BE INCLUDED IN CONTRACTOR'S M.O.T. OR TRAFFIC PAY ITEM AND SHALL BE DONE ON A DAILY BASIS (MIN).
- 10 PERMANENT TURNOUTS AND DRIVEWAYS CONNECTIONS TO PRIVATE PROPERTY THAT LIE OUTSIDE THE LIMITS OF RIGHT-OF-WAY AND WHERE ACCESS RIGHTS HAVE NOT BEEN ACQUIRED SHALL BE CONSTRUCTED IN ACCORDANCE WITH THE TURNOUT DETAILS AND STANDARD SPECIFICATIONS FOR THESE PLANS. THE CONTRACTOR SHALL NOT ISOLATE ADJACENT AND/OR THE REMAINDER OF THE PROPERTY UNLESS ACCESS RIGHTS ARE ACQUIRED. ACCESS SHALL BE PROVIDED TO SUCH PROPERTY WHENEVER CONSTRUCTION INTERFERES WITH THE EXISTING MEANS OF ACCESS.
- 48 HOURS PRIOR TO DIGGING CONTRACTOR SHALL COORDINATE WITH ALL UNDERGROUND UTILITY SERVICE COMPANIES TO VERIFY LOCATION OF ALL UNDERGROUND UTILITIES, ADDITIONALLY, CONTRACTOR SHALL CONTACT SUNSHINE STATE ONE CALL OF FLORIDA, INC. (811) TO ASSURE THAT ALL UTILITIES HAVE BEEN IDENTIFIED.
- 12 CONTRACTOR SHALL VERIFY, PHOTOGRAPH AND INVENTORY THE EXACT LOCATION OF ALL EXISTING TREES, STRUCTURES, PAVEMENT OR OTHER FEATURES. ANY EXISTING STRUCTURE, PAVEMENT, TREE OR OTHER EXISTING FEATURE THAT IS IN CONFLICT OR DAMAGED. EXPOSED OR IN ANY WAY DISTURBED BY CONSTRUCTION PERFORMED UNDER THE CONTRACT AND PROVIDE COPIES TO THE TOWN OF CUTLER BAY AND THE ENGINEER. THEY SHALL BE RESTORED PROMPTLY TO ITS ORIGINAL CONDITION AT NO ADDITIONAL COST TO THE PROJECT.
- 13 THE LOCATION AND SIZE OF THE UTILITIES SHOWN IN THE PLANS ARE APPROXIMATE ONLY. THE EXACT LOCATION SHALL BE DETERMINED BY THE CONTRACTOR DURING CONSTRUCTION. ADDITIONAL UTILITIES MAY EXIST WHICH ARE NOT SHOWN ON PLANS. THE CONTRACTOR SHALL BE RESPONSIBLE FOR THE LOCATION OF ALL EXISTING UTILITIES. THE CONTRACTOR SHALL VERIFY ALL UTILITIES BY ELECTRONIC METHODS AND BY HAND EXCAVATION IN COORDINATION WITH ALL UTILITY COMPANIES, PRIOR TO BEGINNING ANY CONSTRUCTION OPERATION, ANY AND ALL CONFLICTS OF EXISTING UTILITIES WITH PROPOSED IMPROVEMENTS MUST BE RESOLVED BY THE ARCHITECT/ENGINEER AND THE OWNER. THIS WORK BY THE CONTRACTOR SHALL BE CONSIDERED INCIDENTAL TO THE CONTRACT AND NO ADDITIONAL COMPENSATION SHALL BE ALLOWED.

- THE CONTRACTOR SHALL NOTIFY THE CITY IN WRITING AT LEAST 48 HOURS PRIOR TO THE COMMENCEMENT OF CONSTRUCTION.
- 15 UNDERGROUND UTILITY INFORMATION SHOWN HEREON WAS TAKEN FROM "AS-BUILT" DATA PROVIDED BY THE VARIOUS UTILITY COMPANIES AND SUPPLEMENTED BY FIELD MEASUREMENTS WHEN
- 16 CONTRACTOR SHALL BE RESPONSIBLE FOR PROVIDING A PROPER STAGING AREA APPROVED BY THE TOWN OF CUTLER BAY. STOCKPILING OF MATERIAL IN ROADWAY IS NOT ALLOWED.
- 17 UTILITIES NEEDED TO BE ADJUSTED WILL BE ADJUSTED BY OTHERS. CONTRACTOR WILL BE RESPONSIBLE FOR SCHEDULING THESE ADJUSTMENTS WITH THE UTILITY COMPANY.
- THE CONTRACTOR SHALL REQUEST THE LOCATION OF ANY WATER, SEWER OR GAS LATERALS NOT SHOWN IN THE PLANS SERVICING PROPERTIES ADJACENT TO THE PROJECT BEFORE EXCAVATING, THE ADDITIONAL COST OF EXCAVATING AROUND THE LATERALS SERVICING SAID PROPERTIES SHALL BE
- 19 THE CONTRACTOR IS TO USE CAUTION WHEN WORKING, SPECIALLY IN OR AROUND AREAS OF OVERHEAD TRANSMISSION LINES AND UNDERGROUND UTILITIES.
- ANY WATER AND SEWER LINES TO BE ADJUSTED SHALL BE APPROVED BY THE MIAMI-DADE DEPARTMENT OF WATER AND SEWER. THE CONTRACTOR SHALL NOTIFY THE TOWN OF CUTER BAY FOR ANY CONFLICTS DURING CONSTRUCTION FOR ANY IMPROVEMENTS SHOWN ON THE DRAWINGS
- ALL EXISTING ROCK BASE MATERIAL WHICH IS REMOVED IS TO BE INCORPORATED IN THE STABILIZED PORTION OF THE SUBGRADE, AS DIRECTED BY THE ENGINEER.
- NONE OF THE EXISTING ROCK BASE THAT IS REMOVED IS TO BE INCORPORATED INTO THE PROPOSED LIMEROCK BASE
- ALL DISPOSAL OF EXCESS AND UNSUITABLE EXCAVATED MATERIAL, DEMOLITION, VEGETATION, RUBBISH AND DEBRIS SHALL BE MADE OUTSIDE THE LIMITS OF CONTRUCTION AT A LEGAL DISPOSAL SITE PROVIDED BY THE CONTRACTOR AT HIS/HER OWN EXPENSE, WITH THE PRIOR APPROVAL OF THE ENGINEER. MATERIAL CLEARED FROM THE SITE SHALL NOT BE DEPOSITED ON ADJACENT AND/OR NEARBY PROPERTY.
- ALL EXCESS MATERIALS AS DESIGNATED BY THE ENGINEER ARE TO BE DISPOSED OF BY THE CONTRACTOR IN AREAS PROVIDED BY HIM AND AT THE CONTRACTOR'S EXPENSE.
- ALL DRAINAGE CONSTRUCTION SHALL BE IN STRICT ACCORDANCE WITH THE REQUIREMENTS OF TOWN OF CUTLER BAY AND MIAMI-DADE COUNTY DEPARTMENT OF REGULATORY AND ECONOMIC RESOURCES (RER).
- CONTRACTOR TO PROTECT EXISTING INLETS AND DRAINAGE COMPONENTS, ADJACENT TO CONSTRUCTION, THAT MAY BE SILTED OR EXPOSED TO DEBRIS, DURING CONSTRUCTION. INLETS AND OTHER DRAINAGE COMPONENTS THAT ARE SILTED OR FULL OF DEBRIS AFTER CONSTRUCTION TO BE DESILTED/CLEANED BY CONTRACTOR PRIOR TO FINAL INSPECTION AND ACCEPTANCE.
- 27 ALL GRASS AREAS AFFECTED BY CONSTRUCTION SHALL BE RESODDED.
- ALL UNSUITABLE MATERIAL UNDER THE PAVEMENT SHALL BE REMOVED AND REPLACED WITH ACCEPTABLE MATERIALS BEFORE PROCEEDING WITH CONSTRUCTION.
- ALL MUCK AND ORGANIC MATERIALS FOUND WITHIN THE CONSTRUCTION AREA SHALL BE REMOVED AND REPLACED WITH CLEAN FILL MATERIAL IN 6 INCH LIFTS COMPACTED TO NOT LESS THAN 95% MAXIMUM DENSITY AT OPTIMUM MOISTURE IN ACCORDANCE WITH AASHTO T-180.
- THE CONTRACTOR SHOULD TAKE SPECIAL NOTE OF THE SOIL CONDITIONS THROUGHOUT THIS PROJECT. ANY SPECIAL SHORING, SHEETING OR OTHER PROCEDURES NECESSARY TO PROTECT ADJACENT PROPERTY, EITHER PUBLIC OR PRIVATE, DURING EXCAVATION OF SUBSOIL MATERIAL AND EXFILTRATION TRENCH OR DURING THE FILING OF ANY AREA, OR FOR ANY OPERATION DURING CONSTRUCTION SHALL BE THE SOLE RESPONSIBILITY OF THE CONTRACTOR, THE ONLY EXCEPTION WILL BE THE PROTECTION OF UTILITIES. ALL UTILITIES SHALL BE MAINTAINED BY THE OWNER OF
- ANY PUBLIC OR PRIVATE PROPERTY DAMAGED BY CONTRACTOR AT ANY TIME DURING CONSTRUCTION SHALL BE REPLACED OR REPAIRED TO ORIGINAL CONDITION, AT NO EXPENSE TO THE OWNER OR
- EXISTING CHAIN LINK FENCE, CONCRETE WALL AND METAL FENCE WITHIN THE LIMITS OF CONSTRUCTION SHALL BE PROTECTED UNLESS OTHERWISE INDICATED.
- CONTRACTOR SHALL ADJUST ALL EXISTING VALVES BOXES, CATCH BASINS GRATES, MANHOLES COVERS, ETC. TO MEET NEW GRADES WHERE APPLICABLE.
- ALL VALVES, A.R.V.'S, AND MANHOLES TO BE RAISED AND ADJUSTED TO PROPOSED ROADWAY ELEVATION.
- SODDING TO BE USED AT LOCATIONS WHERE EXISTING LAWNS ARE DISTURBED OR AS DIRECTED BY 35 THE ENGINEER.

- ALL TREES ARE TO REMAIN, UNLESS OTHERWISE DIRECTED BY THE ENGINEER. CONTRACTOR MUST TAKE CARE NOT TO DAMAGE ANY TREE OR PALM WITHIN CONSTRUCTION AREA. SMALL TREES OR PALMS MAY BE RELOCATED AS DIRECTED BY THE TOWN OF CUTLER BAY. TREE PERMIT MUST BE OBTAINED PRIOR TO CONSTRUCTION. THERE ARE LARGE TREES WITH EXTENSIVE ROOT NETWORKS ON THE GROUND THAT ARE IMPACTING ADJACENT SIDEWALKS, CURBS AND PAVEMENT. THE CONTRACTOR SHALL BE REQUIRED TO COORDINATE WITH AN ARBORIST TO ENSURE THAT ROOT AND TREE PRUNING ACTIVITIES ARE CONDUCTED IN A MANNER THAT IT DOES NOT HARM OR DESTROY THE
- RADII ON CURB RETURNS ARE TO THE EDGE OF PAVEMENT UNLESS OTHERWISE NOTED.
- PROVIDE A SMOOTH TRANSITION WHERE NEW PAVEMENT, SIDEWALK, OR CURB MEETS EXISTING
- PRIOR TO REMOVAL AND/OR RELOCATION OF EXISTING TREES, IF REQUIRED, THE CONTRACTOR MUST OBTAIN APPROVAL FROM THE TOWN OF CUTLER BAY AS WELL AS D.E.R.M. OTHERWISE CONTRACTOR SHALL PROTECT EXISTING TREES WHERE APPLICABLE WITHIN THE LIMITS OF CONSTRUCTION
- WHERE NEW PAVEMENT MEETS EXISTING CONNECTION SHALL BE MADE IN A NEAT STRAIGHT LINE AND FLUSH WITH EXISTING PAVEMENT. SAW CUT AT EXISTING PAVEMENT JOINT MATCHING TO NEW
- 41 ANY DISCREPANCY FOUND BETWEEN THE PLANS AND THE QUANTITIES SHEET MUST BE IMMEDIATELY BROUGHT TO THE ATTENTION OF THE MUNICIPALITY/COUNTY AND ENGINEER OF RECORD (EOR). AN R.F.I. MUST BE PROVIDED AND SHOULD OUTLINE THE SPECIFIC ISSUE OR DISCREPANCY, PROVIDE SUPPORTING DOCUMENTATION OR EVIDENCE, AND SEEK CLARIFICATION OR APPROVAL BEFORE PROCEEDING WITH THE PROJECT/TASK.

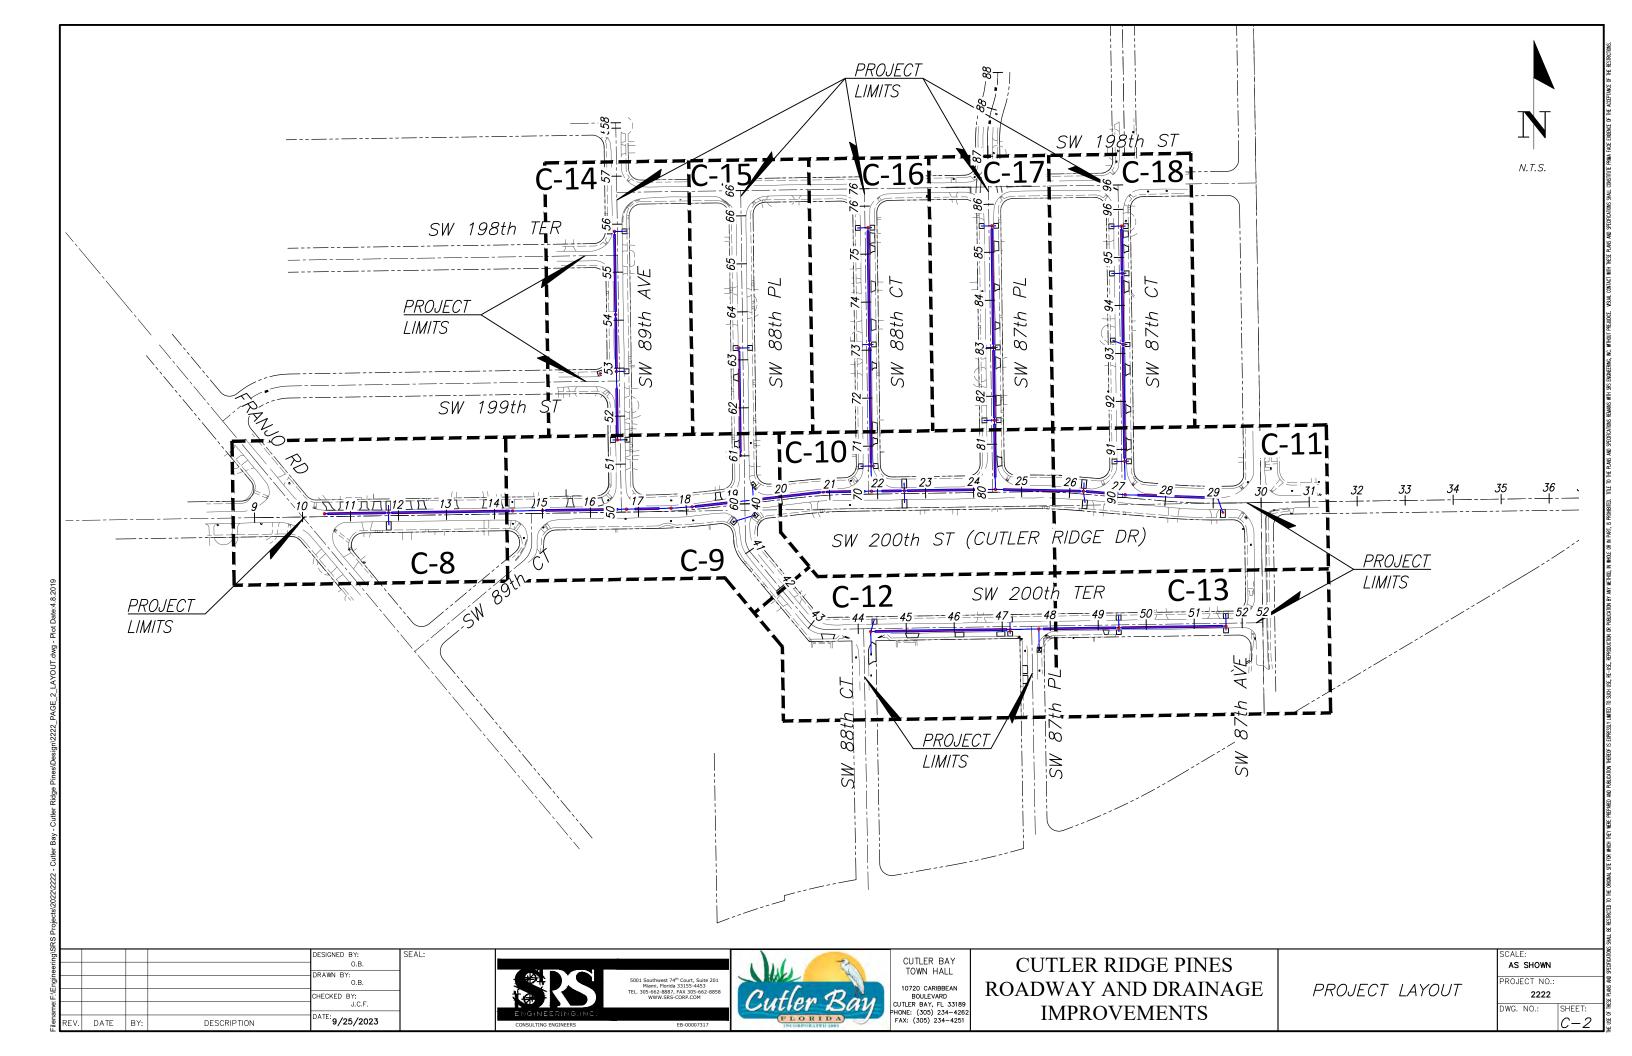DRAINAGE

- CONTRACTOR SHALL KEEP NEW AND EXISTING INLETS CLEAN OF PAVING MATERIALS AND DEBRIS INLETS LOCATED NEAR CONSTRUCTION ACTIVITIES SHOULD BE PROTECTED BY APPROPRIATE EROSION CONTROL DEVICES.
- THERE SHALL BE NO MORE THAN 3 LATERAL DRAINAGE INSTALLATION WITHOUT BACKFILLING. LATERAL DRAINAGE SHALL NOT LAG MORE THAN 72 HOURS BEHIND THE START OF EXCAVATION.
- GRADES SHOWN ARE "FINISHED" GRADES.
- DRAINAGE SYSTEM SHALL BE CLEANED AND DESILTED PRIOR TO PW FINAL INSPECTION APPROVAL.
- EXISTING STRUCTURES AND PIPES TO REMAIN WITHIN LIMITS OF CONSTRUCTION SHALL BE VACUUM
- ANY EXISTING DRAINAGE COMPONENTS TO REMAIN THAT ARE DAMAGED AS A RESULT OF THE CONSTRUCTION ARE TO BE RESTORED TO EXISTING EQUIVALENT OR BETTER CONDITIONS AT THE CONTRACTOR'S EXPENSE.

PRE-CONSTRUCTION RESPONSIBILITIES

- PRIOR TO THE COMMENCEMENT OF THE CONSTRUCTION AND THE RECEIPT OF THE "NOTICE TO PROCEED" THE CONTRACTOR SHALL CONTACT THE TOWN OF CUTLER BAY AND ARRANGE A PRE-CONSTRUCTION CONFERENCE TO INCLUDE THE ENGINEER OF RECORD. THE CONTRACTOR SHALL SUBMIT A CONSTRUCTION SCHEDULE AND BE PREPARED TO DISCUSS ANY CONCERNS OR COORDINATION EFFORTS AND REQUIREMENTS WITH THE PARTIES INVOLVED.
- THE CONTRACTOR SHALL OBTAIN A SUNSHINE STATE ONE CALL OF FLORIDA, INC. CERTIFICATION NUMBER AT LEAST 48 HOURS PRIOR TO BEGINNING ANY EXCAVATION. CONTACT 811, WWW.SUNSHINE811.COM

PROJECT RECORD DOCUMENTS

- DURING THE DAILY PROGRESS OF THE JOB THE CONTRACTOR SHALL RECORD THE EXACT LOCATION, LENGTH, AND ELEVATION OF ALL PROPOSED IMPROVEMENTS ON HIS SET OF CONSTRUCTION
- UPON COMPLETION OF CONSTRUCTION AND PRIOR TO FINAL PAYMENT, THE CONTRACTOR SHALL SUBMIT TO THE ENGINEER TWO COMPLETE SETS OF ALL "AS-BUILT" CONSTRUCTION DRAWINGS, THE DRAWINGS SHALL INCLUDE CHANGES AND DIMENSIONS, LOCATIONS AND ELEVATIONS OF ALL IMPROVEMENTS AND SHALL BE IN ACCORDANCE WITH THE "SURVEY WORK" SECTION OF THE "SPECIFICATIONS AND CONTRACT DOCUMENTS" FOR THIS PROJECT.
- ALL "AS-BUILT" INFORMATION AND ELEVATIONS SHALL BE CERTIFIED BY A FLORIDA REGISTERED LAND SURVEYOR AND ALL FINAL MEASUREMENTS ARE TO BE IN THE FORM OF FIELD NOTES, PLANS AND CD (PDF FORMAT).

DESIGNED BY CHECKED BY: OATE: 9/25/2023 DATE BY: DESCRIPTION





TOWN HALL 10720 CARIBBEAN BOULEVARD CUTLER BAY, FL 33189 HONF: (305) 234-426

CUTLER RIDGE PINES ROADWAY AND DRAINAGE **IMPROVEMENTS**

GENERAL NOTES

AS SHOWN PROJECT NO

- TWO FULL BUSINESS DAYS (48 HOURS) PRIOR TO DIGGING, THE CONTRACTOR SHALL CONTACT 811, WWW.SUNSHINE811.COM TO REQUEST UTILITY LOCATIONS BEFORE BEGINNING ANY CONSTRUCTION
- EXISTING UTILITIES SHALL BE MAINTAINED IN SERVICE DURING CONSTRUCTION UNLESS OTHERWISE APPROVED BY THE UTILITY OWNER. ALL EXISTING UTILITIES ARE TO REMAIN UNLESS OTHERWISE
- IT SHALL BE THE CONTRACTOR'S SOLE RESPONSIBILITY TO (VERTICALLY AND HORIZONTALLY) PROTECT ALL EXISTING UTILITIES ON THIS PROJECT. ANY DAMAGE TO UTILITIES SHALL BE IMMEDIATELY REPORTED TO THE UTILITY OWNER. THE OWNER RESERVES THE RIGHT TO REMEDY SUCH DAMAGE BY ORDERING OUTSIDE PARTIES TO MAKE SUCH REPAIRS AT THE EXPENSE TO THE CONTRACTOR.
- THE CONTRACTOR IS ADVISED THAT PROPERTIES ADJACENT TO THE PROJECT HAVE ELECTRIC, TELEPHONE, GAS, WATER AND/OR SEWER SERVICE LATERALS WHICH MAY NOT BE SHOWN IN PLANS. THE CONTRACTOR MUST REQUEST THE LOCATION OF THESE LATERAL SERVICES FROM THE UTILITY COMPANIES. THE ADDITIONAL COST OF EXCAVATING, INSTALLING, BACKFILLING AND COMPACTING AROUND THESE LATERAL SERVICES MUST BE INCLUDED IN THE BID RELATED ITEM FOR THE WORK
- UTILITY OWNERS:
 - ATLANTIC BROADBAND 786-251-5989 - FLORIDA POWER & LIGHT 386-586-6403 - LEVEL 3 COMMUNICATIONS 786-256-1554 COMCAST CABLE 954-447-8405 - M-D WATER & SEWER - FLORIDA CITY GAS 786-575-8547 786-268-5320

AT&T

ENVIRONMENTAL NOTES

- PUBLIC WORKS & TRAFFIC 786-345-0986

- DUE TO THE LIMITED SCOPE OF WORK, NO IMPACTS TO EXISTING HISTORICAL AND CULTURAL RESOURCES ARE EXPECTED AS A RESULT OF THE PROPOSED ACTION.
- NO STAGING OR OTHER ACTIVITIES FOR THIS PROJECT SHOULD OCCUR WITHIIN THE DRIPLINE OF
- PREVENT DAMAGING TREES AND PLANTERS WITHIN OR IMMEDIATELY ADJACENT TO THE PROJECT'S RIGHT-OF-WAY.
- AN ARBORIST CERTIFIED BY THE INTERNATIONAL SOCIETY OF ARBORICULTURE SHALL BE PRESENT ON SITE TO MONITOR CONSTRUCTION ACTIVITIES NEAR EXISTING TREES AND DIRECT ALL ROOT PRUNING AND/OR CANOPY TRIMMING ACTIVITIES.
- TREE PROTECTION SHOULD BE INSTALLED AROUND TREES TO REMAIN LOCATED ADJACENT TO CONSTRUCTION ACTIVITIES PER FDOT STANDARDS PLANS FY 2023-24, INDEX 110-100
- THE CONTRACTOR SHALL NOT REMOVE, RELOCATE OR PRUNE ANY TREES WITHOUT PRIOR APPROVAL FROM THE TOWN. THE CONTRACTOR SHALL OBTAIN ALL REQUIRED PERMITS FROM THE TOWN OF CUTLER BAY PUBLIC WORKS DEPARTMENT PRIOR TO ANY TREE REMOVAL/RELOCATION.
- CONTRACTOR SHALL REMOVE/CONTROL DUST USING WATER OR OTHER EQUIPMENT CAPABLE OF CONTROLLING DUST.
- THE CONTRACTOR SHALL BE RESPONSIBLE FOR OBTAINING A DERM CLASS V DEWATERING PERMIT IF DEWATERING IS PROPOSED.

TRAFFIC CONTROL PLANS

- TRAFFIC CONTROLS SHALL BE IN ACCORDANCE WITH THE PROJECT PLANS, THE CURRENT EDITION OF THE FDOT, STANDARDS PLANS FY 2023-24 (102 SERIES), THE STANDARD SPECIFICATION FOR ROAD AND BRIDGE CONSTRUCTION, AND 2009 (MUTCD) MANUAL OF UNIFORM CONTROL DEVICE FOR STREETS AND HIGHWAYS, EDITION WITH REVISION NUMBERS 1, 2, AND 3, DATED JULY 2022
- NOTIFICATION OF LANE CLOSURES OR TEMPORARY DETOURS SHALL BE ACCOMPLISHED 14 WORKING DAYS PRIOR TO CLOSURE. DETOUR OR MOT PHASE CHANGE SHALL BE SUBMITTED WITH THE REQUIRED LANE CLOSURE FORM, SKETCHES, CALCULATIONS, AND OTHER DATA TO PUBLIC WORKS
- AT THE DISCRETION OF THE ENGINEER. IF A LANE CLOSURE CAUSES EXTENDED CONGESTION OR DELAY, THE CONTRACTOR SHALL BE DIRECTED TO REOPEN THE CLOSED LANE(S) UNTIL SUCH TIME THAT THE TRAFFIC FLOW HAS RETURNED TO AN ACCEPTABLE LEVEL.
- THE TRAFFIC AND TRAVEL WAYS SHALL NOT BE ALTERED BY THE CONTRACTOR TO CREATE A WORK ZONE UNTIL ALL LABOR AND MATERIAL ARE AVAILABLE FOR THE CONSTRUCTION IN THAT AREA.
- LANE CLOSURE SHALL OCCUR ONLY DURING NON-PEAK HOURS ON NON-EVENT DATS/NIGHTS/WEEKENDS. NON PEAK HOURS 9:00 AM TO 3:30 PM WEEKDAYS AND SATURDAYS. EXCÉPTIONS MAY BE GRANTED UPON WRITTEN REQUEST TO THE CITY.
- TRAFFIC CONTROL PLANS FOR ALL PHASES ARE DESIGNED FOR NON-PEAK HOURS ONLY. THE CONTRACTOR SHALL KEEP ALL EXISTING LANES OPEN DURING PEAK HOURS IN THESE PHASES.

- AS DETERMINED BY THE ENGINEER, THE CONTRACTOR SHALL COVER WORK ZONE SIGNS WHEN CONDITIONS NO LONGER WARRANT THEIR USE. COST OF COVERING AND UNCOVERING THE SIGNS SHALL BE INCLUDED IN MAINTENANCE OF TRAFFIC PAY ITEM.
- CONTRACTOR SHALL BE RESPONSIBLE FOR THE IMMEDIATE REMOVAL OF STORM WATER FROM ROADWAYS UTILIZED FOR MAINTAINING TRAFFIC IN A MANNER APPROVED BY THE ENGINEER. COST FOR REMOVING THE WATER SHALL BE INCLUDED IN MAINTENANCE OF TRAFFIC PAY ITEM.
- TEMPORARY LANE TRANSITIONS, SHIFTS, AND CROSSOVERS SHALL HAVE SOLID LANE AND EDGE LINES FOR THE LENGTH OF THE TRANSITION, SHIFT OR CROSSOVER. IN ADDITION, SOLID LANE AND EDGE LINES SHALL EXTEND 100 FT ON TANGENT BEYOND EACH END OF THE TRANSITION, SHIFT, OR CROSSOVER. EXCEPTION SHALL BE THROUGH INTERSECTIONS WHERE 2 FT TO 4 FT SKIP LINES
- ALL TEMPORARY STRIPES AND MARKINGS SHALL BE PAINT ONLY, UNLESS OTHERWISE SPECIFIED ON THE PLANS OR APPROVED BY THE ENGINEER. COST OF TEMPORARY STRIPING SHALL BE INCLUDED
- EACH EXISTING STREET NAME AND STOP SIGN AFFECTED BY CONSTRUCTION SHALL BE RELOCATED AND MAINTAINED IN AN APPROPRIATE LOCATION FOR THE DURATION OF THE PROJECT. WHEN NO LONGER AFFECTED BY CONSTRUCTION, THESE SIGNS SHALL BE RESTORED TO THEIR ORIGINAL POSITION. COST OF TEMPORARILY RELOCATING AND RESTORING THE SIGNS SHALL BE INCLUDED IN MAINTENANCE OF TRAFFIC PAY ITEM.
- FOR DROP OFFS, THE CONTRACTOR'S SHALL FOLLOW TO THE FDOT, STANDARDS PLANS FY 2023-24 INDEX NO. 102-600 SHEET 8 OF 11. THE CONTRACTOR SHALL USE SHOULDER TREATMENT DETAIL WHEN NO BARRIERS ARE REQUIRED IN THE PLANS
- CONTRACTOR SHALL PREPARE AND SUBMIT AN ACCEPTABLE MOT PLAN FOR THE PROJECT. THE MOT PLAN SHALL BE SUBMITTED TO THE TOWN OF CUTLER BAY'S PUBLIC WORKS DEPARTMENT FOR
- LANE CLOSURES SHALL NOT BE PERMITTED DURING SCHOOL SPEED ZONE HOURS WHERE SUCH CLOSURES WILL AFFECT TRAFFIC FLOW IN THE VICINITY OF THE SCHOOL SPEED ZONES.

WORK ZONE LIMITS

561-997-0240

- THE LENGTH OF AN OPEN TRENCH SHALL NOT EXCEED 500 FT. PROPERTY ACCESS SHALL BE MAINTAINED IN ACCORDANCE TO ARTICLE 102- 5.5 OF THE FDOT STANDARD SPECIFICATIONS FOR ROAD AND BRIDGE CONSTRUCTION LATEST EDITION.
- NO MORE THAN TWO BLOCKS OF STREET SHALL BE UNDER CONSTRUCTION AT A TIME AND ALL WORK AND RESTORATION SHALL BE COMPLETED ON ONE OF SUCH BLOCKS BEFORE WORK MAY BEGIN IN A NEW BLOCK. FINAL RESURFACING SHALL BE PLACED WITHIN 48 HOURS OF THE MILLING OPERATION.

INTERSECTIONS

- ADJACENT INTERSECTIONS SHALL NOT BE CONSTRUCTED SIMULTANEOUSLY UNLESS DIRECTED BY THE
- INTERSECTIONS SHALL BE RECONSTRUCTED WORKING ON A CONTINUOUS DAILY BASIS UNTIL COMPLETE AND UNTIL THE STRUCTURAL COURSE IS PLACED.
- M.O.T. TRANSITIONS AND TEMPORARY INTERSECTION CROSSOVERS WHERE CONSTRUCTION HAS CAUSED GRADE DIFFERENCES BETWEEN THE EXISTING AND NEW ROADWAYS SHALL BE CONSTRUCTED USING A 1:20 TYPE SP ASPHALT CONCRETE SLOPE TO ACCOMMODATE VEHICULAR TRAFFIC FROM ANY DIRECTION. ALL MATERIAL AND WORK, INCLUDING ITS REMOVAL, SHALL BE INCLUDED IN MAINTENANCE OF TRAFFIC PAY ITEM.

PEDESTRIANS, BICYCLES, AND WHEELCHAIRS

- AT THE END OF EACH WORK DAY OR WHENEVER THE WORK ZONE BECOMES INACTIVE, ANY DROP OFF GREATER THAN 6 IN. ADJACENT TO THE PEDESTRIAN, BICYCLE, AND WHEELCHAIR TRAVEL PATHS SHALL BE BACKFILLED FLUSH WITH THE SAID PATHS OR PROTECTED WITH TEMPORARY FENCE, CONCRETE BARRIER WALL OR APPROVED HANDRAIL. COST SHALL BE INCLUDED IN THE PAY ITEM 102-1, MAINTENANCE OF TRAFFIC.
- CONSTRUCTION ACTIVITIES THAT INVOLVES SIDEWALKS ON BOTH SIDES OF THE STREET ARE NOT ALLOWED UNLESS APPROVED BY THE ENGINEER.

SIGNING AND PAVEMENT MARKINGS

- ALL SIGNING AND PAVEMENT MARKINGS SHALL CONFORM WITH THE CURRENT EDITION OF THE FDOT, STANDARDS PLANS FY 2023-24, THE 2023 FDOT DESIGN MANUAL, AND 2009 (MUTCD) MANUAL OF UNIFORM CONTROL DEVICE FOR STREETS AND HIGHWAYS
- ALL EXISTING SIGNS ARE TO REMAIN UNLESS OTHERWISE SPECIFIED. BEFORE STARTING THE PROJECT, THE CONTRACTOR WILL REVIEW EXISTING SIGNS SHOWN ON THE PLANS TO BE RELOCATED OR TO REMAIN. THE CONTRACTOR WILL NOTIFY IN WRITING TO THE PROJECT ENGINEER OF ANY MISSING SIGNS BEFORE CONSTRUCTION STARTS. SIGNS DAMAGED BY THE CONTRACTOR'S OPERATIONS WILL BE REPLACED AT NO COST TO THE DEPARTMENT. IF EXISTING SIGNS TO BE RELOCATED HAVE A DAMAGED POLE OR A POLE NOT MEETING HEIGHT SPECIFICATION REQUIREMENTS, THE COST OF A NEW POLE WILL BE INCLUDED IN THE RELOCATION BID ITEM.

TOWN HALL

10720 CARIBBEAN

- ALL PAVEMENT MARKINGS, MESSAGES, AND ARROWS SHALL BE THERMOPLASTIC UNLESS OTHERWISE NOTED
- REFLECTIVE PAVEMENT MARKERS ARE TO BE PLACED AS INDICATED
- MATCH EXISTING PAVEMENT MARKINGS AT THE BEGINNING AND AT THE END OF THE PROJECT AND AT ALL SIDE STREETS WITHOUT JOGS OR OFFSETS.
- THE CONTRACTOR SHALL REMOVE EXISTING MARKINGS BY FDOT APPROVED METHOD WITHOUT DAMAGE TO THE FRICTION COURSE.
- SIGN ASSEMBLY LOCATIONS SHOWN ON PLANS WHICH ARE IN CONFLICT WITH LIGHTING, UTILITIES, DRIVEWAYS, WHEELCHAIR RAMPS, ETC. MAY BE ADJUSTED SLIGHTLY AS DIRECTED BY THE ENGINEER. EXTREME LOCATION CHANGES MUST BE APPROVED BY MIAMI-DADE SIGNALS AND SIGNS DIVISION.
- THE CONTRACTOR SHALL RELOCATE ALL EXISTING POST-MOUNTED STREET NAME AND STOP SIGNS TO A VISIBLE AREA UNDISTURBED BY THE CONSTRUCTION SO AS TO MINIMIZE DAMAGE TO THE SIGNS. NEW STREET NAME SIGNS WILL BE ATTACHED AT THE TOP OF THE NEW STOP SIGNS ON MINOR SIDE STREETS AT THE END OF CONSTRUCTION.
- EXTRUDED ALUMINUM SIGN SUPPORT CLAMPS ARE NOT ACCEPTABLE. ALL RELOCATED SIGNS MUST COMPLY WITH THE FDOT, STANDARDS PLANS FY 2023-24, INDEX 700-010 AS IF THEY WERE NEW SIGNS. IF EXISTING CLAMPS, BRACKETS, POLES, ETC. NEED TO BE REPLACED THE COST SHALL BE INCLUDED IN THE RELOCATION PAY ITEM.
- 10 REFLECTIVE PAVEMENT MARKERS AS PER FDOT STANDARD INDEX NO 706-001
- 11 NEW STREET NAME SIGNS SHALL BE PER MIAMI DADE COUNTY STANDARDS AND MUTCD.

GENERAL NOTES

AS SHOWN PROJECT NO. 2222

DWG. NO.:


ESIGNED BY CHECKED BY: J.C.F ATE: 9/25/2023 DATE BY: DESCRIPTION






CUTLER RIDGE PINES ROADWAY AND DRAINAGE **IMPROVEMENTS**

ABBREVIATIONS: BLDG. = BUILDING C.B. = CATCH BASIN = BASE LINE = CENTER LINE C.O. = CLEANOUT = CONCRETE = CONNECTION CONN. CONT. = CONTINUATION CONST. = CONSTRUCT DET. = DETAIL D.I.P. = DUCTILE IRON PIPE EXIST. = EXISTING F.F.E. = FINISHED FLOOR ELEVATION = FIRE HYDRANT F.H. / FH F.M. / FM = FORCE MAIN H.D.P.E. = HIGH DENSITY POLYETHYLENE = HORIZONTAL = INVERT INV. L.F. = LINEAR FEET = MIAMI-DADE WATER AND SEWER DEPT. M-DWASD M-DPW = MIAMI DADE PUBLIC WORKS = MATCH EXISTING GRADE M.E.G. MIN. = MINIMUM P.I.V. = POST INDICATOR VALVE P.G.P. = PROPOSED GRADING POINT = PROPOSED GRADING LINE P.G.L. P/L, = PROPERTY LINE = PROPOSED = SANITARY SEWER SAN. = RIGHT OF WAY R/W, ROW SEC. = SECTION SERV. = SERVICE = SECTION LINE S/L, STA. = STATION STD. = STANDARD

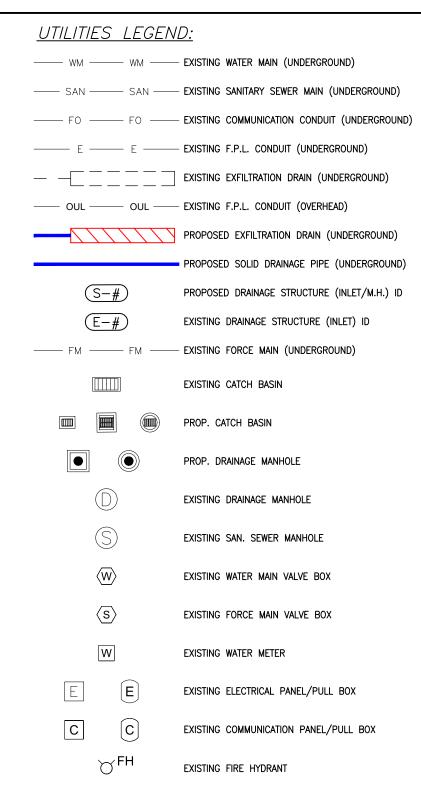

ROADWAY PLANS LEGEND:

- XX AMOUNT OF SIDEWALK FLAG TO BE REPLACED
- EXISTING SANITARY SEWER / DRAINAGE MANHOLE TO BE ADJUSTED BY A LICENSED CONTRACTOR
- EXISTING WATER/FORCE MAIN/GAS VALVE BOX & LID TO BE ADJUSTED BY A LICENSED CONTRACTOR
- (3) EXISTING WATER METER BOX TO BE REPLACED
- CONTINGENCY: REPLACE EXIST. CONCRETE DRIVEWAY BY 6" CONCRETE DRIVEWAY (MATCH EXIST. LAYOUT AND STAMP PATTERN)
- EXIST. SD PIPE TO BE CUT AND INSTALL PROP. DRAINAGE MANHOLE. RECONNECT EXIST. SD PIPE TO PROP. DRAINAGE MANHOLE W/ 4 LF OF SOLID PIPE
- CONSTRUCT 6" CONC. SIDEWALK, HANDICAP RAMPS, DRIVEWAYS & INLET APRONS
- AREA TO BE RESODDED.
- PROP. DETECTABLE WARNING PER FDOT INDEX 522-002
 - MILLING EXISTING ASPHALT PAVEMENT (½" AVERAGE)
 RESURFACING WITH 1 LIFT (1") OF SP-9.5 ASPHALTIC CONCRETE SURFACE COURSE
 (INSTALL W/ THE SECOND LIFT OF THE PAVEMENT RESTORATION AND NEW PAVEMENT)
- CONTINGENCY: EXIST. ASPHALT DRIVEWAY TO BE RESURFACED W/ 1" SP-9.5 CONCRETE ASPHALT.
- CONTINGENCY: EXIST. PAVER DRIVEWAY TO BE RESURFACED. SEE PAVER DRIVEWAY RESTORATION DETAIL SHEET C-33
- NEW PAVEMENT/ WIDENING/ DRAINAGE TRENCH RESTORATION
 - 2 LIFTS OF (1") SP-9.5 ASPHALTIC CONC.
 - 8" MIN. BASE COURSE COMPACTED TO MIN. 98% (MODIFIED PROCTOR) MIN. LBR=100 PER AASHTO T-180)
 - 12" STABILIZED SUBBASE, COMPACTED TO MIN. 98%, MIN. LBR=40, PER AASHTO T-180

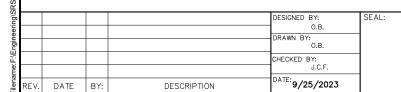

= SIDEWALK

= TOP OF PIPE

= US FOUNDRY

= WATER SERVICE

= TO BE FIELD VERIFIED

VERTICALWATER MAIN

T.O.P.

U.S.F

VERT.

T.B.F.V.

W.M. / WM







CUTLER RIDGE PINES ROADWAY AND DRAINAGE IMPROVEMENTS

LEGEND AND ABBREVIATIONS SCALE:
AS SHOWN
PROJECT NO.:

2222 DWG. NO.: SHEE

SHEET:

102-1	HIGHWAYS, U.S. DEPARTMENT OF TRANSPORTATION FEDERAL HIGHWAY ADMINISTRATION. PUBLIC WORKS MANUAL OF MIAMI DADE COUNTY, THE LATEST REVISIONS OF THE AFOREMENTIONED MANUALS AT TIME OF CONSTRUCTION WITH ENGINEER APPROVAL, AND IN ACCORDANCE WITH THE LATEST FLORIDA DEPARTMENT OF TRANSPORTATION DESIGN STANDARDS INDEX 102 SERIES. INCLUDES THE COST OF CONSTRUCTION OF TEMPORARY PAVEMENT & ITS SUBSEQUENT REMOVAL.
104-18	THIS ITEM IS TO BE USED IN ACCORDANCE WITH THE PLANS, STANDARDS, AND/OR EROSION AND SEDIMENT CONTROL MANUAL FOR THE PROTECTION OF EXISTING INLETS. PAYMENT PER EACH INLET INCLUDES ALL WORK AND MATERIALS FOR A COMPLETE SYSTEM. PROPOSED INLETS: THE PAYMENT FOR PROTECTING NEW INLETS IS INCIDENTAL TO THE COST OF THE NEW INLET. CURB INLET FILTERS, CURB INSERT PROTECTION SYSTEMS, PIPE END CAP FILTERS, DITCH BOTTOM INLET PROTECTION SYSTEMS ("CAPS", BARRIERS, AND OTHER MATERIALS), ARE INCLUDED IN THIS PAY ITEM.
110-1-1	CONSISTS OF COMPLETE REMOVAL AND DISPOSAL OF ALL VEGETATION, DEBRIS, DRAINAGE STRUCTURES, DRAINAGE PIPES, FLEXIBLE PAVEMENT, OR ANY OTHER OBSTRUCTIONS IN ALL AREAS WHERE EXCAVATION IS TO BE DONE, OR WHERE EMBANKMENTS OR STRUCTURES WILL BE CONSTRUCTED. THIS INCLUDES ROADWAY AREA, DITCH AREA, BORROW AND MATERIAL PITS, AND AREAS WHERE CULVERTS OR PIPELINES WILL BE CONSTRUCTED. ALSO INCLUDES SHRUB AND TREE TRIMMING. ALL DEBRIS SHOULD BE DISPOSED OF IN LEGAL AREAS PROVIDED BY THE CONTRACTOR.
110-4-10	CONSISTS OF REMOVING AND DISPOSING OF EXISTING CONCRETE PAVEMENT, CONCRETE SIDEWALKS, CONCRETE APRONS, DITCH PAVEMENT, CONCRETE PAVERS, AND CURB AND GUTTER.
120-4	THE DISPOSAL OF MUCK, CLAY, ROCK, OR OTHER UNSUITABLE MATERIAL THAT COULD EXIST.
120-6	INCLUDES ALL WORK AND MATERIALS (SUITABLE MATERIAL) PER FDOT SECTION 120 AND INDEX 120-001 REPLACE WITH CLEAN FILL THE VOLUME OF SUBSOIL EXCAVATION (PAY ITEM 120-4).
125-1	INCLUDES EXCAVATION FOR BOX CULVERTS, PIPE CULVERTS (SOLID PIPE), INLETS, MANHOLES, AND SIMILAR STRUCTURES. BASE AND SUB-BASE EXCAVATION WITHIN TRENCH RESTORATION IS INCLUDED IN THIS PAID ITEM. THESE ARE ESTIMATED QUANTITIES AND MAY BE INCREASED OR DECREASED.
160-4	INCLUDES ALL WORK AND MATERIALS SPECIFIED IN SECTION 160 (FDOT STANDARD SPECIFICATIONS FOR ROAD AND BRIDGE CONSTRUCTION), INCLUDING FURNISHING, SPREADING, AND MIXING OF ALL STABILIZING MATERIAL REQUIRED AND ANY REPROCESSING OF STABILIZATION AREAS NECESSARY TO ATTAIN THE SPECIFIED BEARING VALUE.
327-70-16	CONSISTS OF REMOVING EXISTING AC PAVEMENT TO IMPROVE THE RIDEABILITY OF THE FINISHED PAVEMENT, TO LOWER THE FINISHED GRADE ADJACENT TO EXISTING CURB PRIOR TO RESURFACING, OR TO COMPLETELY REMOVE EXISTING PAVEMENT. INCLUDES TRANSPORTING THE MILLED MATERIAL TO THE ASPHALT PLANT SITE AND STOCKPILING THE MATERIAL. ALSO INCLUDES REMOVAL OF EXISTING REFLECTIVE PAVEMENT MARKER
425-1-SERIES 425-2-SERIES	INCLUDES: POLLUTION RETARDANT BAFFLE, FRAME, GRATES, COVERS, MATERIALS, METAL PIPE ENCASEMENT, INLET PROTECTION (PAY ITEM DESCRIPTION 104-18), LABOR AND CONSTRUCTION SHALL BE INCLUDED IN COST OF STRUCTURES.
425-5 & 425-6	WITHIN PAVEMENT AREA, MANHOLES AND VALVE BOXES TO BE ADJUSTED AS NECESSARY.
430-174-SERIES	INCLUDES FURNISHING AND PLACING: PIPE PLUGS, PIPE FITTING, CAPS, CONCRETE JACKET AND SOLID PIPES.
443-174-SERIES	INCLUDES: EXCAVATION TO PLAN ELEVATION (15 FEET DEEP, SEE DETAILS SHEETS), FURNISHING AND PLACING: (PIPE PLUGS, PIPE FITTINGS, PERFORATED PIPES, BALLAST ROCK AND BACKFILLING WITH SELECT FILL, FILTER FABRIC AND ALL APPLICABLE ITEMS REQUIRED TO CONSTRUCT DRAIN). ALSO, IT IS INCLUDED THE ADDITIONAL COST OF EXCAVATING AROUND THE LATERALS SERVICING SAID PROPERTIES.
522-2	ESTIMATED QUANTITY FOR: DRIVEWAYS, SIDEWALK, RAMPS, APRON, AND CONC. SLAB (REINFORCED) TO BE CONSTRUCTED AT LOCATIONS SHOWN IN THE PLANS AND/OR AS DIRECTED BY THE ENGINEER.
526-1-1	INCLUDES ALL LABOR AND MATERIALS (PAVER, SAND LEVELING COURSE, 6" LIMEROCK, AND ANY PROCESSING OR MATERIAL NECESSARY TO COMPLETE PAVER INSTALLATION.)
570-1-2	INCLUDES TOPSOIL LAYER AND SOD TO BE USED IN THE RESTORATION OF LAWNS AND MAY BE INCREASED OR DECREASED AS DIRECTED BY THE TOWN OF CUTLER BAY. BAHIA SOD OR TO MATCH EXISTING SOD.
	DECIDIES DV. SEAL.

ESIGNED BY:

CHECKED BY: J.C.F.

DESCRIPTION

DATE BY:

^{0ATE:}9/25/2023

CONTRACTOR SHALL FURNISH AS-BUILT PLANS SIGNED AND SEALED BY AND PROFESSIONAL LAND SURVEYOR TO THE TOWN OF

TO BE ACCOMPLISHED IN ACCORDANCE WITH THE MANUAL OF UNIFORM TRAFFIC CONTROL DEVICES FOR STREETS AND

PAY ITEM DESCRIPTION

102-1

CUTLER BAY

QUANTITIES AND PAY ITEM NOTES:

- 1. EXCESS AND/OR UNDESIRABLE MATERIAL TO BE DISPOSED OF BY CONTRACTOR IN LEGAL AREAS PROVIDED BY HIM. NO SEPARATE PAYMENT WILL BE MADE FOR THIS ITEM.
- 2. EXCESS MATERIAL TO BE DISPOSED OF BY THE CONTRACTOR IN AREAS PROVIDED BY HIM. NO SEPARATE PAYMENT WILL BE MADE FOR THIS ITEM.
- 3. ANY EXCAVATED MATERIAL, IF UNSUITABLE, SHALL NOT BE USED IN THE CONSTRUCTION OF THE EMBANKMENT.
- 4. ASPHALT DRIVEWAY RESTORATION IS INCLUDED IN THE PAY ITEM 334-1-13 (CONTINGENCY).
- 5. THE CONTINGENCY ITEM MUST BE APPROVED BY THE ENGINEER ON RECORD AND THE TOWN.
- 6. THE 5 L.F. OF SOLID PIPE ON BOTH SIDES OF THE FRENCH DRAIN ARE INCLUDED IN THE QUANTITIES LISTED UNDER PAY ITEMS 430-174-SERIES AND 125-1 (EXCAVATION)
- 7. THE PRICE FOR CUTTING AND RECONNECTING EXISTING DRAINAGE PIPES TO THE PROPOSED DRAINAGE SYSTEM IS INCLUDED IN PAY ITEMS 425-1-SERIES AND 425-2-SERIES.
- 8. REFER TO FDOT'S "DESIGN QUANTITIES AND ESTIMATES" (DQE) FOR MORE INFORMATION ON THE PAYMENT ITEM DESCRIPTIONS.

CUTLER BAY **CUTLER RIDGE PINES** TOWN HALL 10720 CARIBBEAN BOULEVARD CUTLER BAY, FL 33189 PHONE: (305) 234-4262 ROADWAY AND DRAINAGE **IMPROVEMENTS**


PAY ITEMS NOTES

AS SHOWN PROJECT NO.: 2222

Item	Pay Item No.	Description	Quantity	Unit Measure
1	001	AS BUILT	1	LS
2	101-1	MOBILIZATION	1	LS
3	102-1	MAINTENANCE OF TRAFFIC	1	LS
4	102-14	TRAFFIC CONTROL OFFICER ALLOWANCE	300	HR
5	104-18	INLET PROTECTION SYSTEM (EXISTING INLETS)	28	EA
6	110-1-1	CLEARING AND GRUBBING	1	LS
7	110-4-10	REMOVAL OF EXISTING CONCRETE	460	SY
8	125-1	EXCAVATION FOR STRUCTURES AND SOLID PIPES	5,381	CY
9	160-4	TYPE B STABILIZATION	4,465	SY
10	285-706	LIMEROCK BASE (8") (OPTIONAL BASE, BASE GROUP 06)	4,465	SY
11	327-70-16	MILLING EXISTING ASPHALT PAVEMENT (1/2" AVG. DEPTH)	13,150	SY
12	334-1-13	SUPERPAVE ASPHALTIC CONC, TRAFFIC C, SP-9.5 (1")	1,250	TN
13	425-1-2B	SD-3.1 SWALE INLET TYPE D-1 (17" x 27") < 10' (M-DPWD PAY ITEM)	38	EA
14	425-1-2A	SD-2.2 SWALE INLET TYPE D-3 (36" Dia.) < 10' (M-DPWD PAY ITEM)	2	EA
15	425-1-481	INLETS, CURB, TYPE 8, <10'	4	EA
16	425-1-482	INLETS, CURB, TYPE 8, >10'	1	EA
17	425-1-604	SD-2.7 SWALE INLETS (TYPE-P), <10' (M-DPWD PAY ITEM)	1	EA
18	425-1-604A	SD-2.7 SWALE INLETS (TYPE-P), >10' (M-DPWD PAY ITEM)	2	EA
19	425-2-41	SD-2.7 MANHOLES, P-7, < 10' (M-DPWD PAY ITEM)	12	EA
20	425-2-42	SD-2.7 MANHOLES, P-7, > 10' (M-DPWD PAY ITEM)	9	EA
21	425-2-71	SD-2.6 MANHOLES, J-7, < 10' (M-DPWD PAY ITEM)	7	EA
22	425-2-72	SD-2.6 MANHOLES, J-7, > 10' (M-DPWD PAY ITEM)	8	EA
23	425-5	MANHOLE, ADJUST	26	EA
24	425-6	VALVE BOXES, ADJUST	20	EA
25	425-79	CORE AND TIE-IN TO EXISTING DRAIN STRUCTURE (18" PIPE, INCL. MORTAR SEAL) (M-DPWD PAY ITEM)	6	EA
26	430-94-1	DESILTING PIPE, 0 - 24	610	LF
27	430-174-115	PIPE CULVERT, OPTIONAL MATERIAL, ROUND, 15"SD	55	LF
28	430-174-118	PIPE CULVERT, OPTIONAL MATERIAL, ROUND, 18"SD (HDPE)	1,855	LF
29	443-70-3	EXFILTRATION DRAIN (18")	4,050	LF
30	520-1-10	CONCRETE CURB & GUTTER, TYPE F	125	LF
31	520-2-4	CONCRETE CURB, TYPE D	60	LF
32	520-3	VALLEY GUTTER- CONCRETE	35	LF
33	522-2	CONCRETE SIDEWALK (6" THICK) (SIDEWALK, RAMP, APRON, DRIVEWAY & SALB)	1,450	SY
34	527-2	DETECTABLE WARNINGS	150	SF
35	570-1-2	PERFORMANCE TURF, SOD	6,000	SY
36	1080-211	UTILITY FIXTURE, VALVE/METER BOX, FURNISH & INSTALL	3	EA

	PAVEMENT MARKING AND SIGNAGE							
Item	Pay Item No.	Description	Quantity	Unit Measure				
37	710-11-101	PAINTED PAVEMENT MARKINGS, STANDARD, WHITE, SOLID, 6"	0.03	GM				
38	710-11-123	PAINTED PAVEMENT MARKINGS, STANDARD, WHITE, SOLID FOR CROSSWALK AND ROUNDABOUT, 12"	2,000	LF				
39	710-11-125	PAINTED PAVEMENT MARKINGS, STANDARD, WHITE, SOLID FOR STOP LINE OR CROSSWALK, 24"	330	LF				
40	710-11-201	PAINTED PAVEMENT MARKINGS, STANDARD, YELLOW, SOLID, 6"	0.50	GM				
41	711-1-11	W1-2A-R CURVE ADVISORY SPEED RIGHT SIGN (PANEL ONLY)	2	EA				
42	711-1-11	W1-2A-L CURVE ADVISORY SPEED LEFT SIGN (PANEL ONLY)	2	EA				
43	700-1-11	SINGLE POST SIGN, F&I GROUND MOUNT, UP TO 12 SF	4	AS				
44	700-1-50	SINGLE POST SIGN, RELOCATE	8	AS				
45	700-1-60	SINGLE POST SIGN, REMOVE	1	AS				
46	706-1-1	RAISED PAVEMENT MARKER, TYPE B WITHOUT FINAL SURFACE MARKINGS (Y/Y)	96	EA				
47	706-1-1	RAISED PAVEMENT MARKER, TYPE B WITHOUT FINAL SURFACE MARKINGS (BLUE)	5	EA				
48	711-11-123	THERMOPLASTIC, STANDARD, WHITE, SOLID, 12" FOR CROSSWALK AND ROUNDABOUT	2,000	LF				
49	711-11-125	THERMOPLASTIC, STANDARD, WHITE, SOLID, 24" FOR STOP LINE AND CROSSWALK	330	LF				
50	711-16-101	THERMOPLASTIC, STANDARD-OTHER SURFACES, WHITE, SOLID, 6"	0.03	GM				
51	711-16-201	THERMOPLASTIC, STANDARD-OTHER SURFACES, YELLOW, SOLID, 6"	0.50	GM				

		CONTINGENCY ITEMS		
Item	Pay Item No.	Description	Quantity	Unit Measure
52	110-4-10	REMOVAL OF EXISTING CONCRETE AND PAVERS +(30% ITEM # 7)	590	SY
53	120-4	SUBSOIL EXCAVATION	100	CY
54	120-6	EMBANKMENT	100	CY
55	334-1-13	SUPERPAVE ASPHALTIC CONC, TRAFFIC C, SP-9.5 (1") DRIVEWAYS + (10% ITEM # 12)	145	TN
56	522-2	CONCRETE DRIVEWAYS (6" THICK) + (30% ITEM # 33)	750	SY
57	526-1-1	PAVERS, ARCHITECTURAL, ROADWAY	120	SY

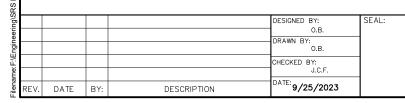








CUTLER BAY TOWN HALL 10720 CARIBBEAN BOULEVARD CUTLER BAY, FL 33189 PHONE: (305) 234-4262 FAX: (305) 234-4251


CUTLER RIDGE PINES ROADWAY AND DRAINAGE SUMMARY OF QUANTITIES PROJECT NO.: **IMPROVEMENTS**


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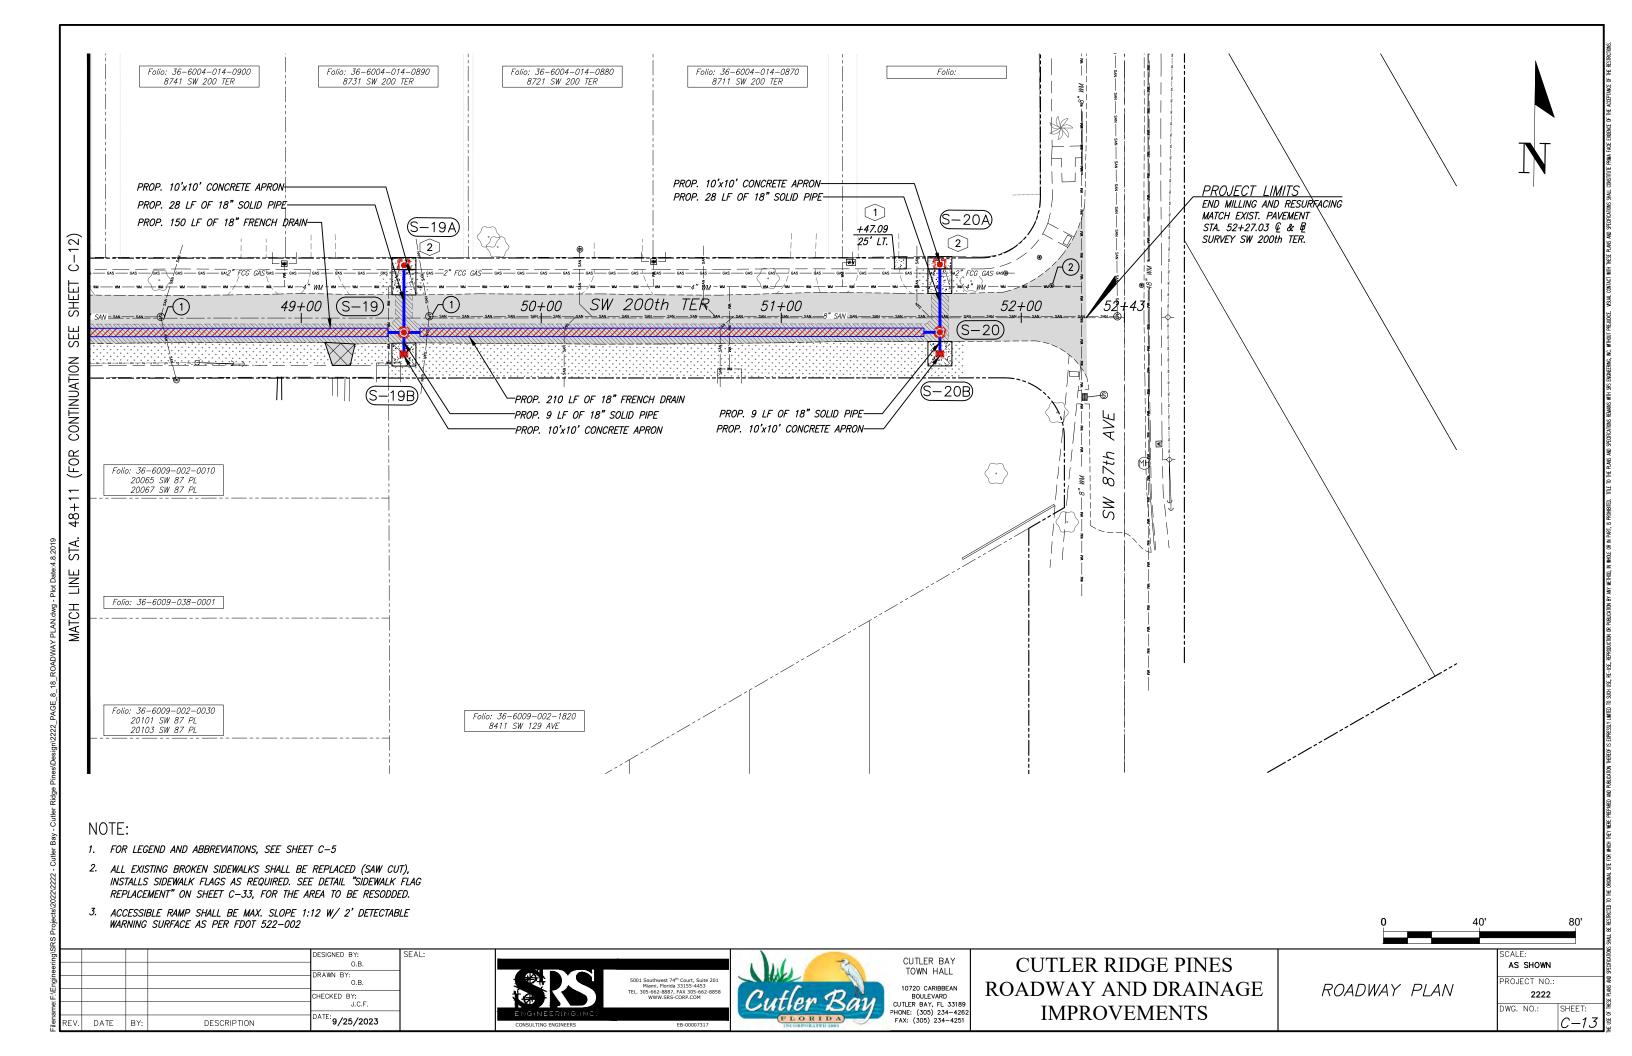


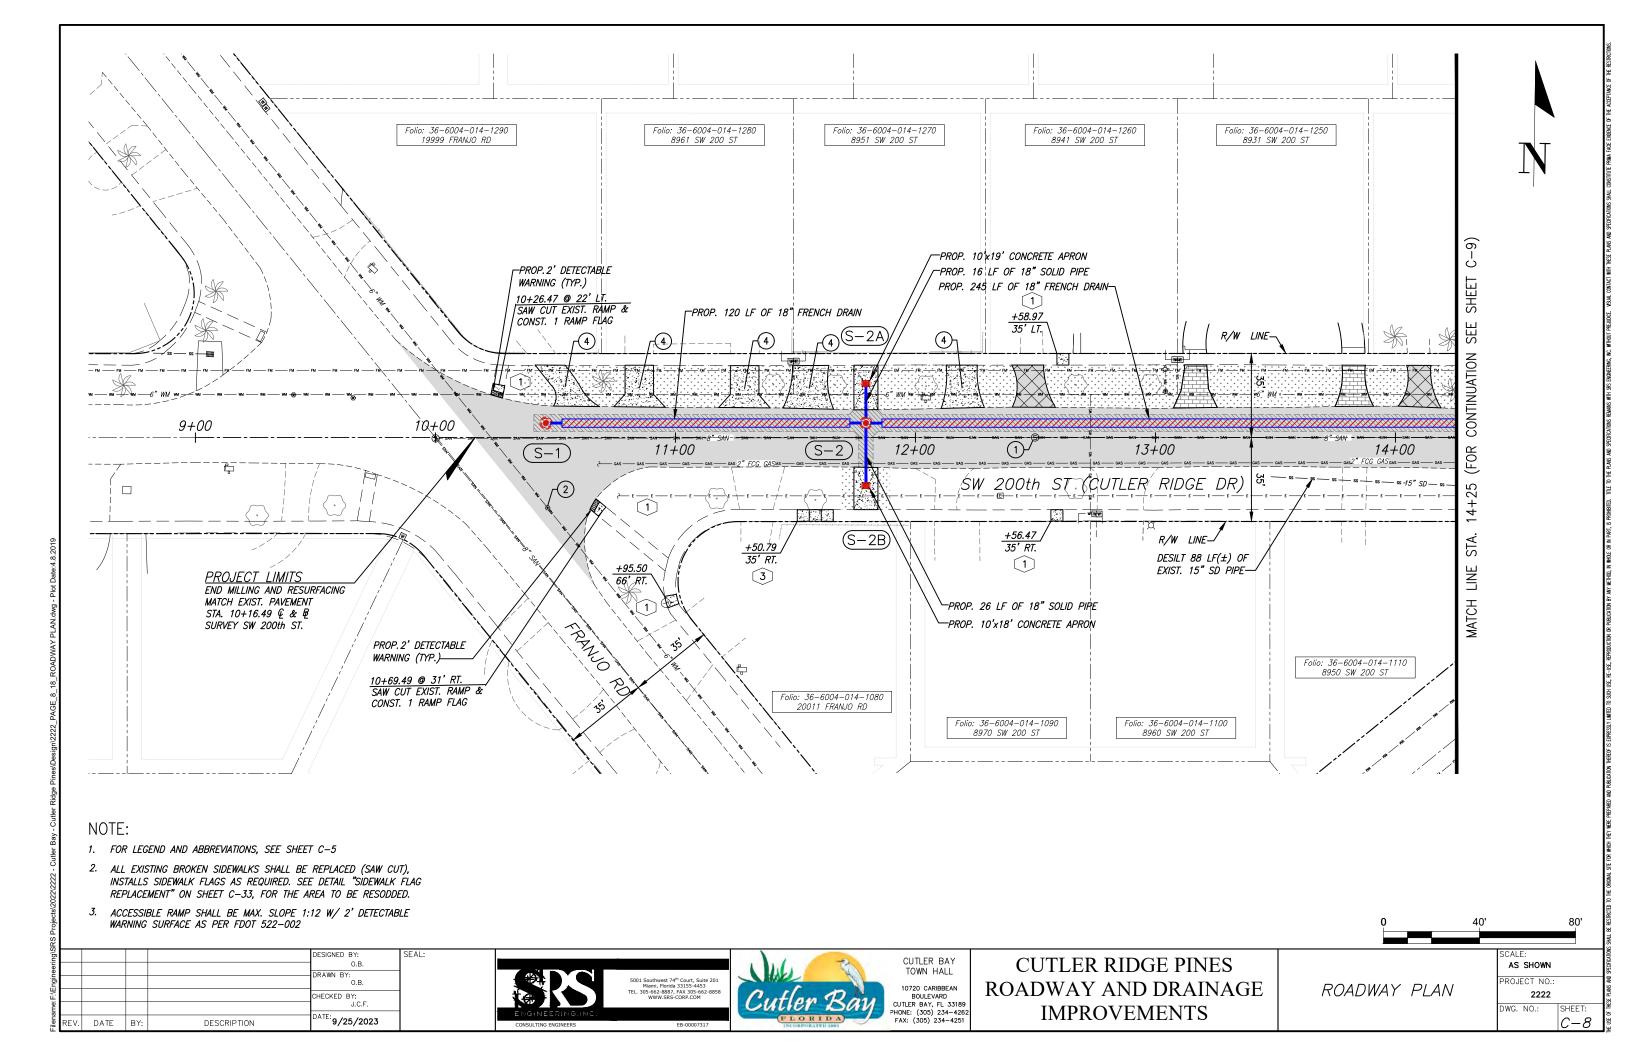


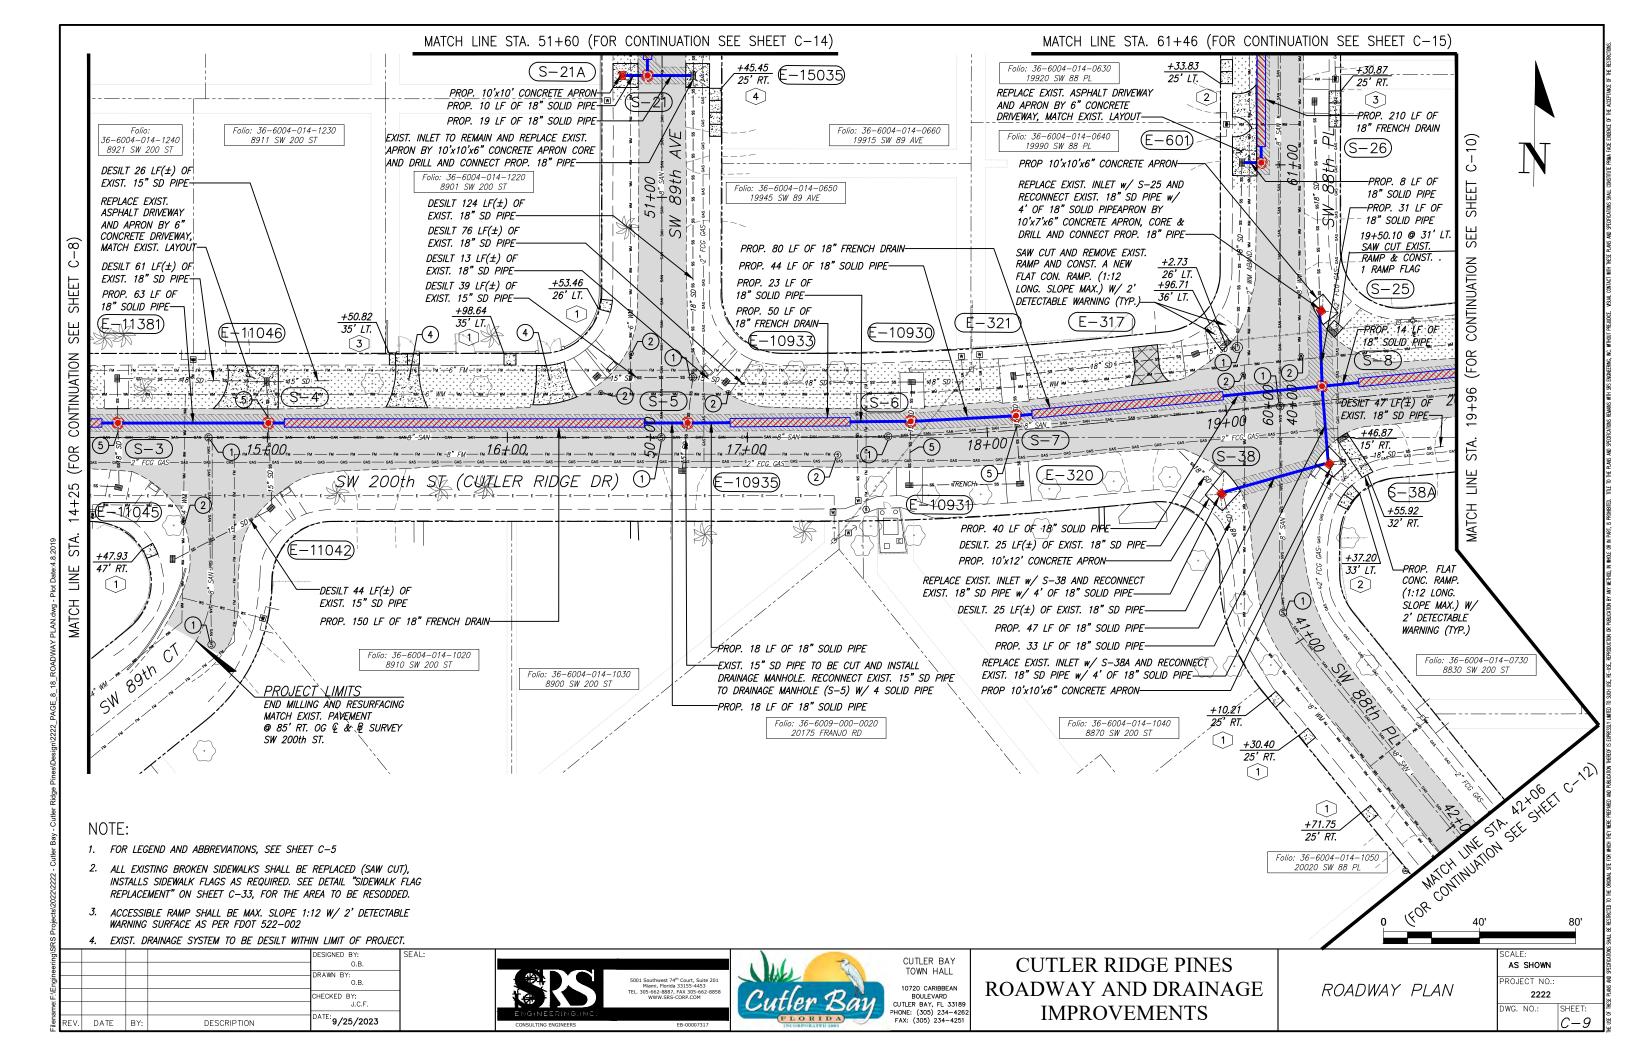


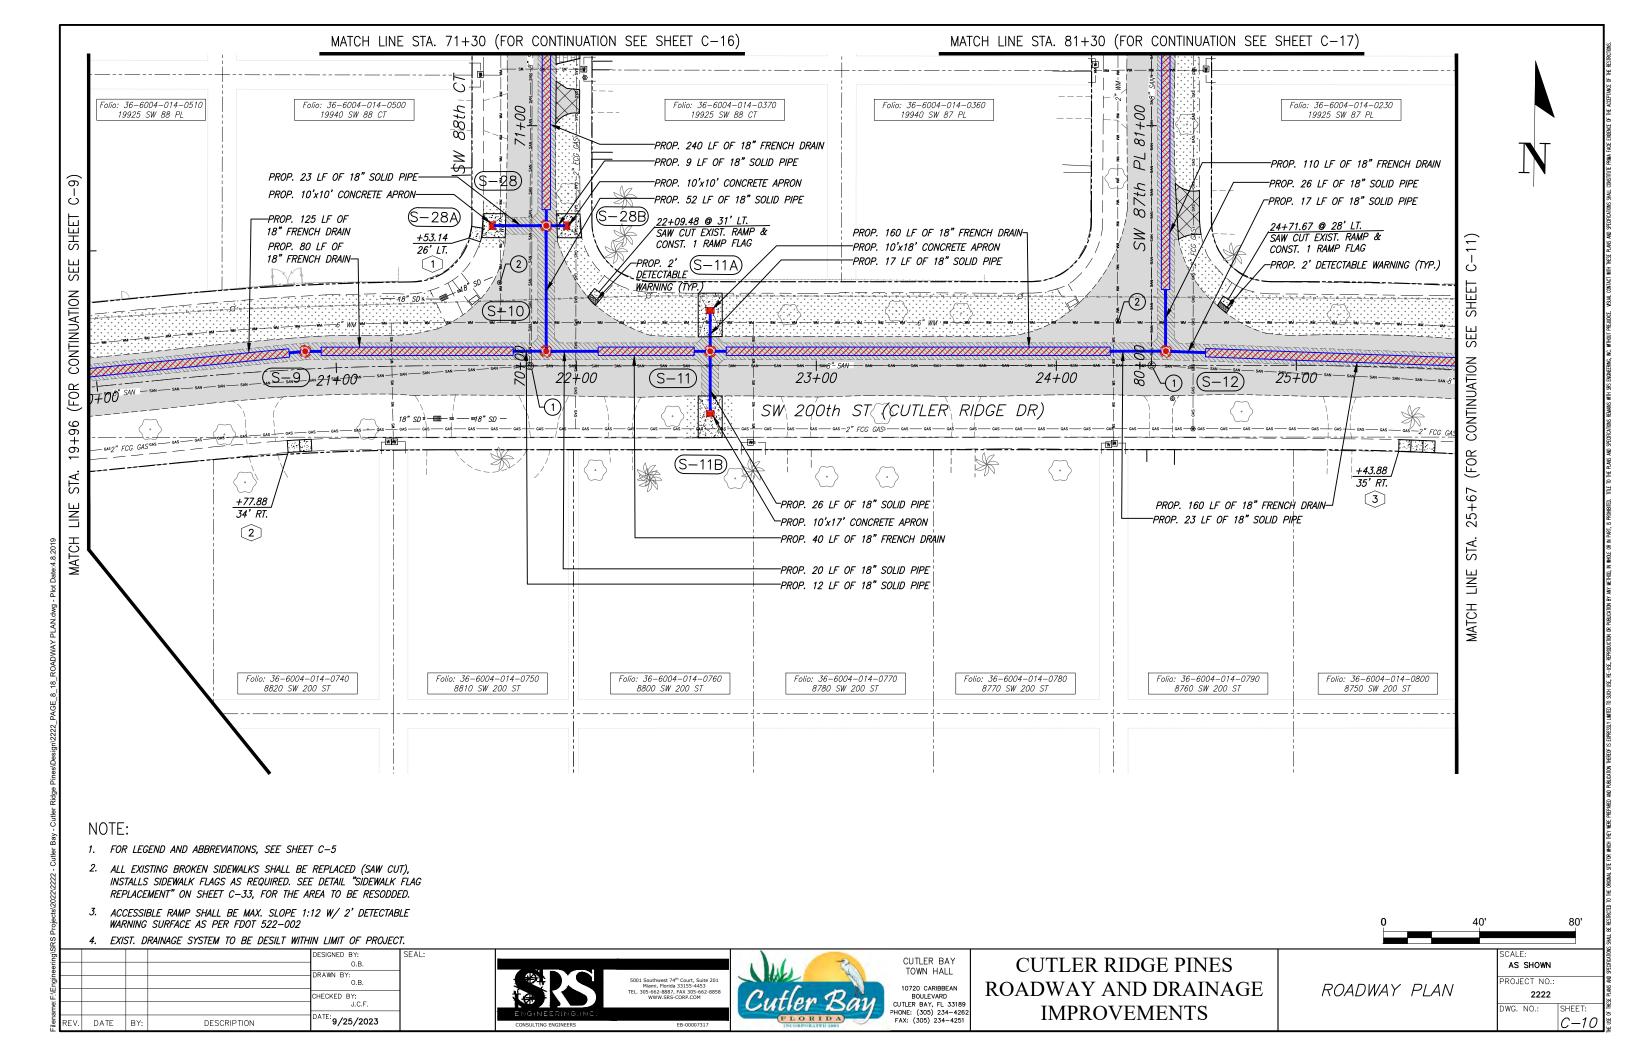

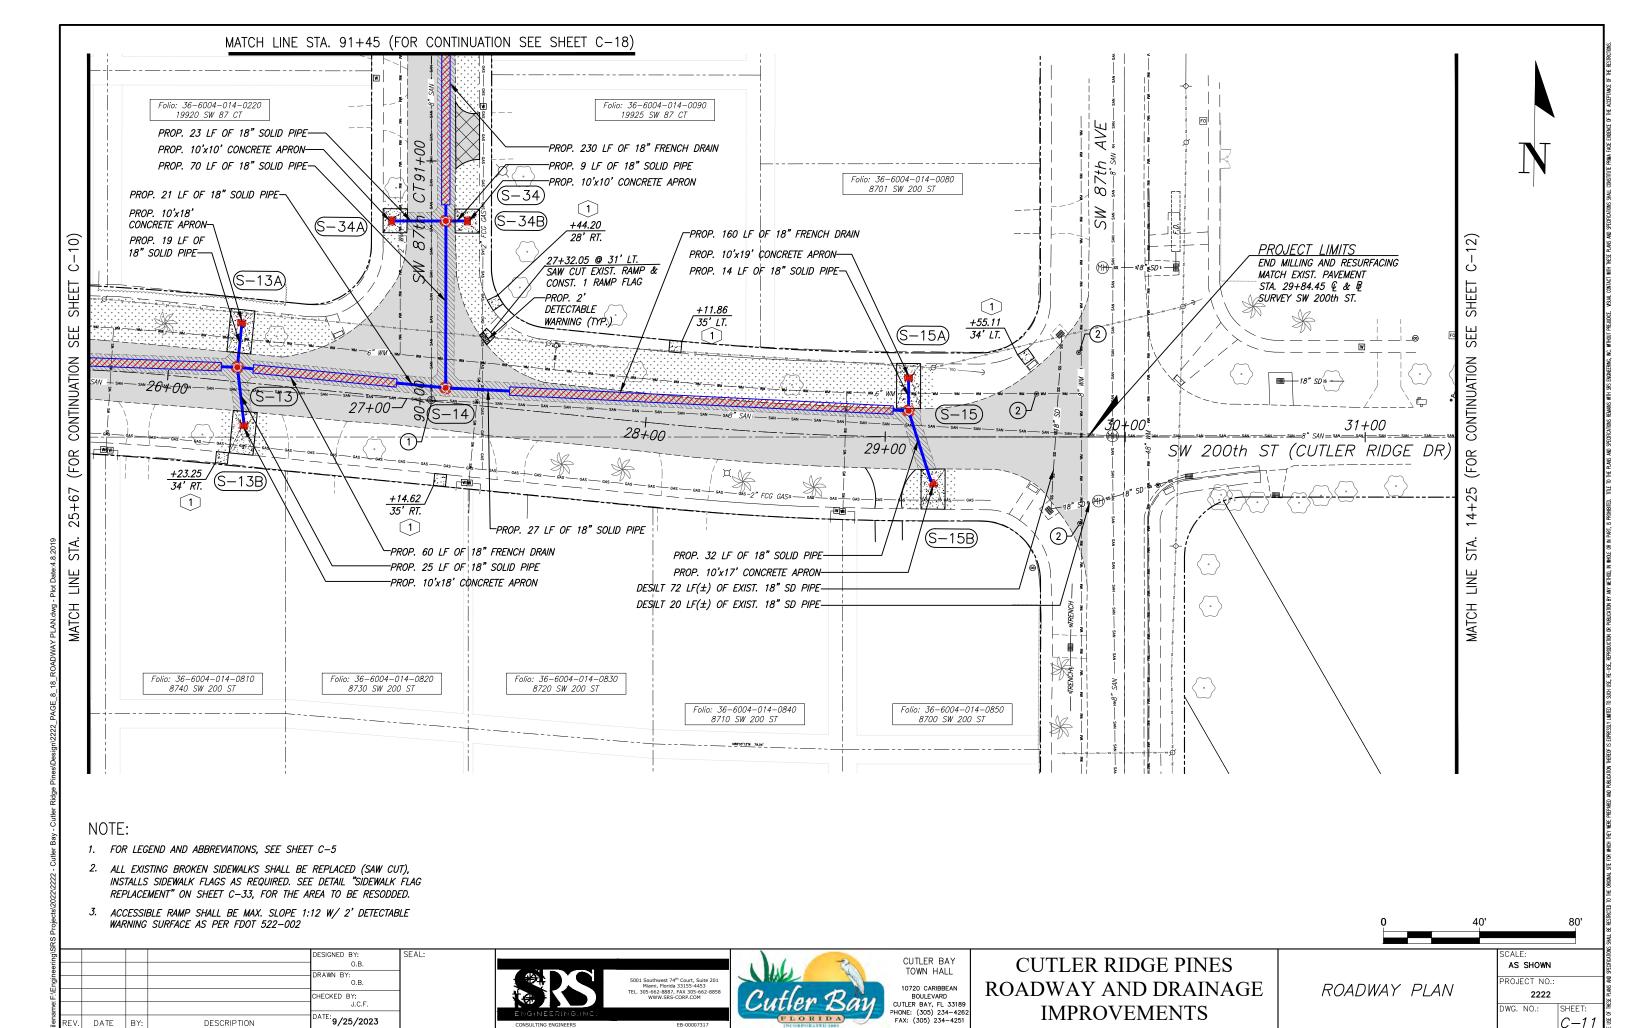

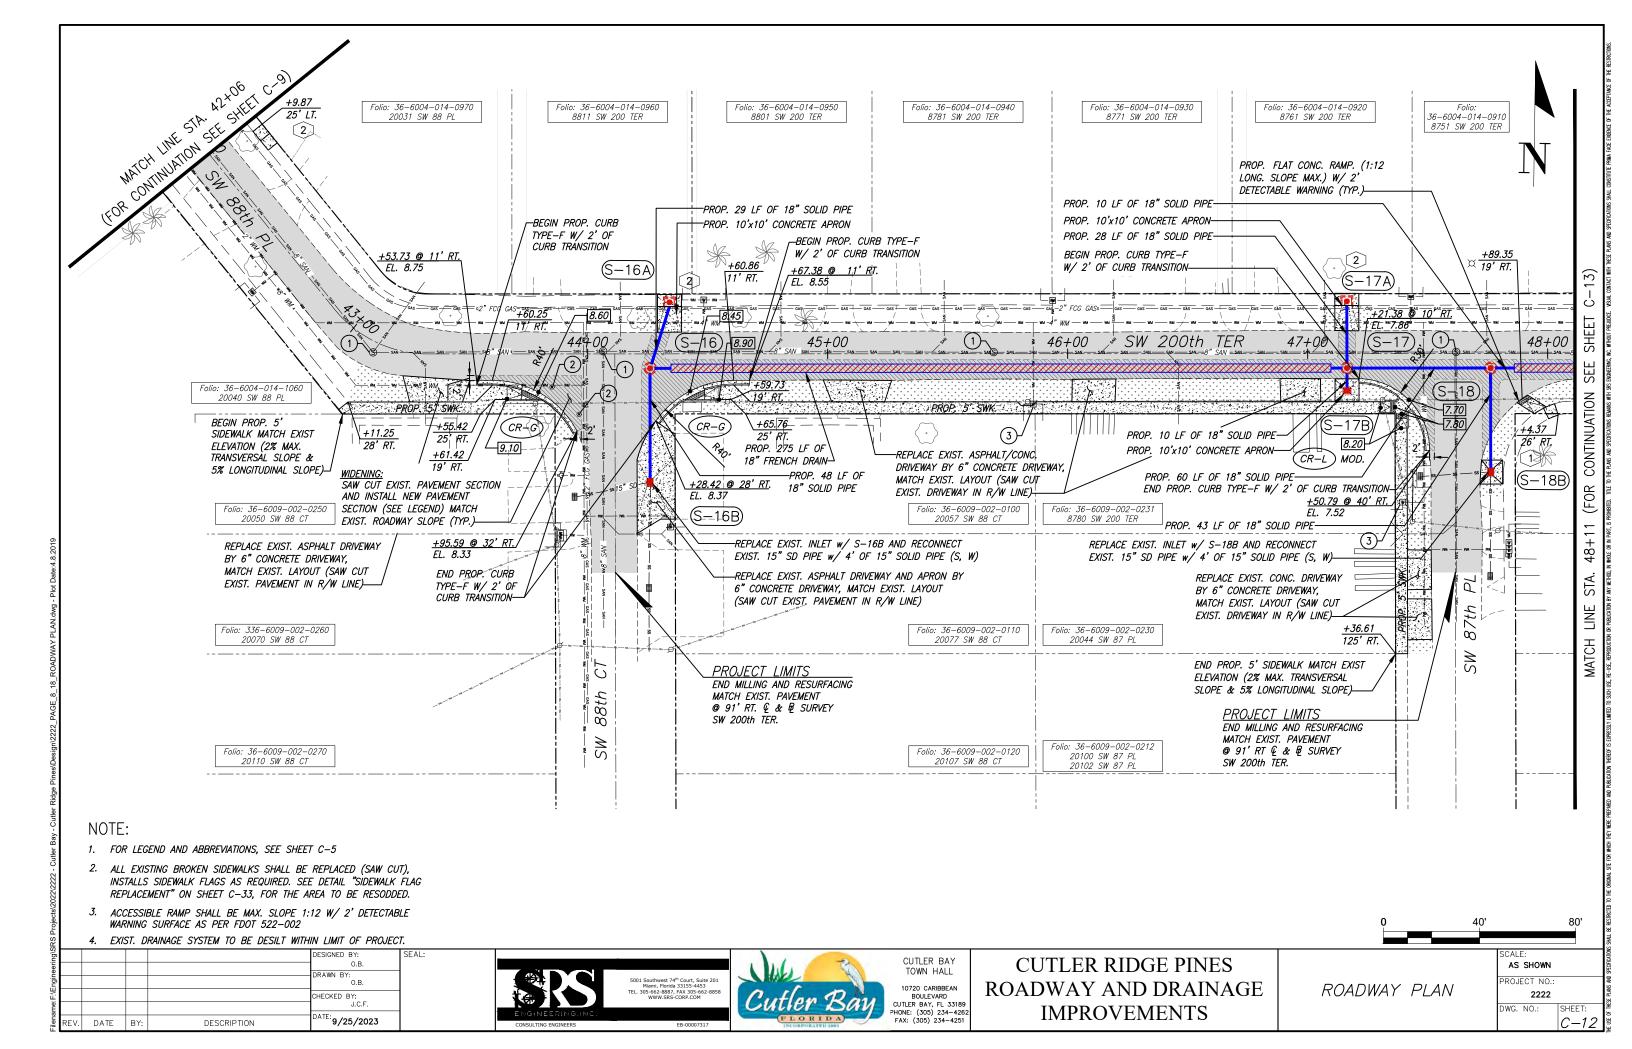

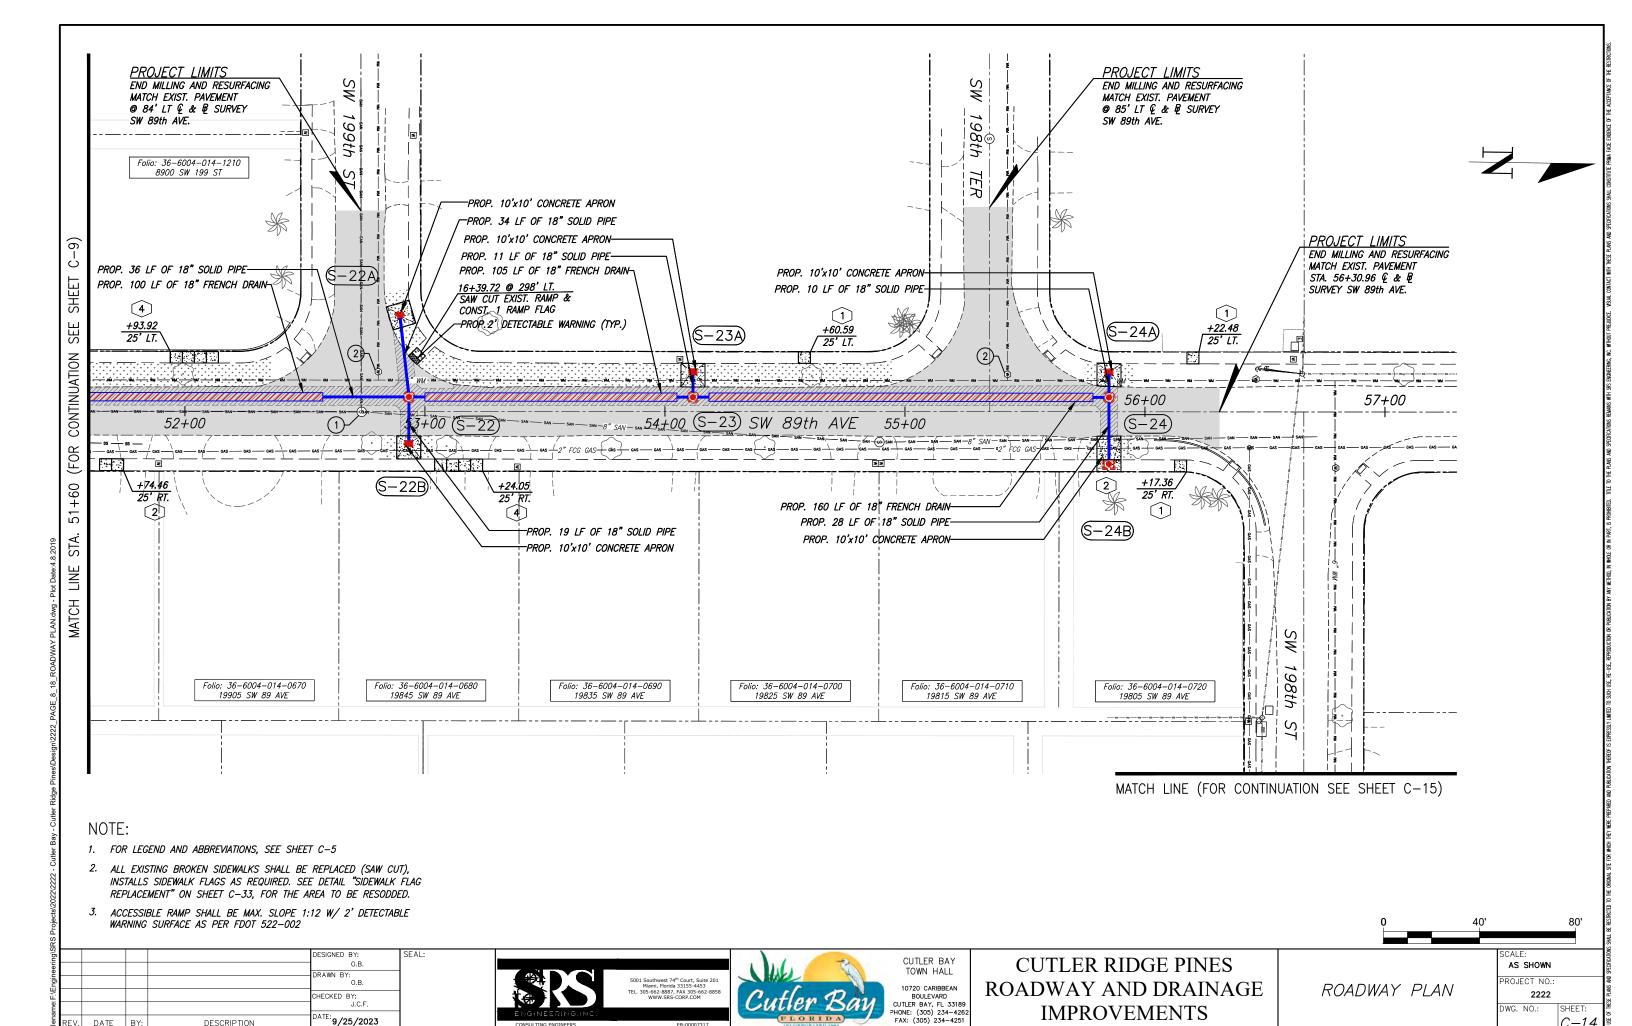


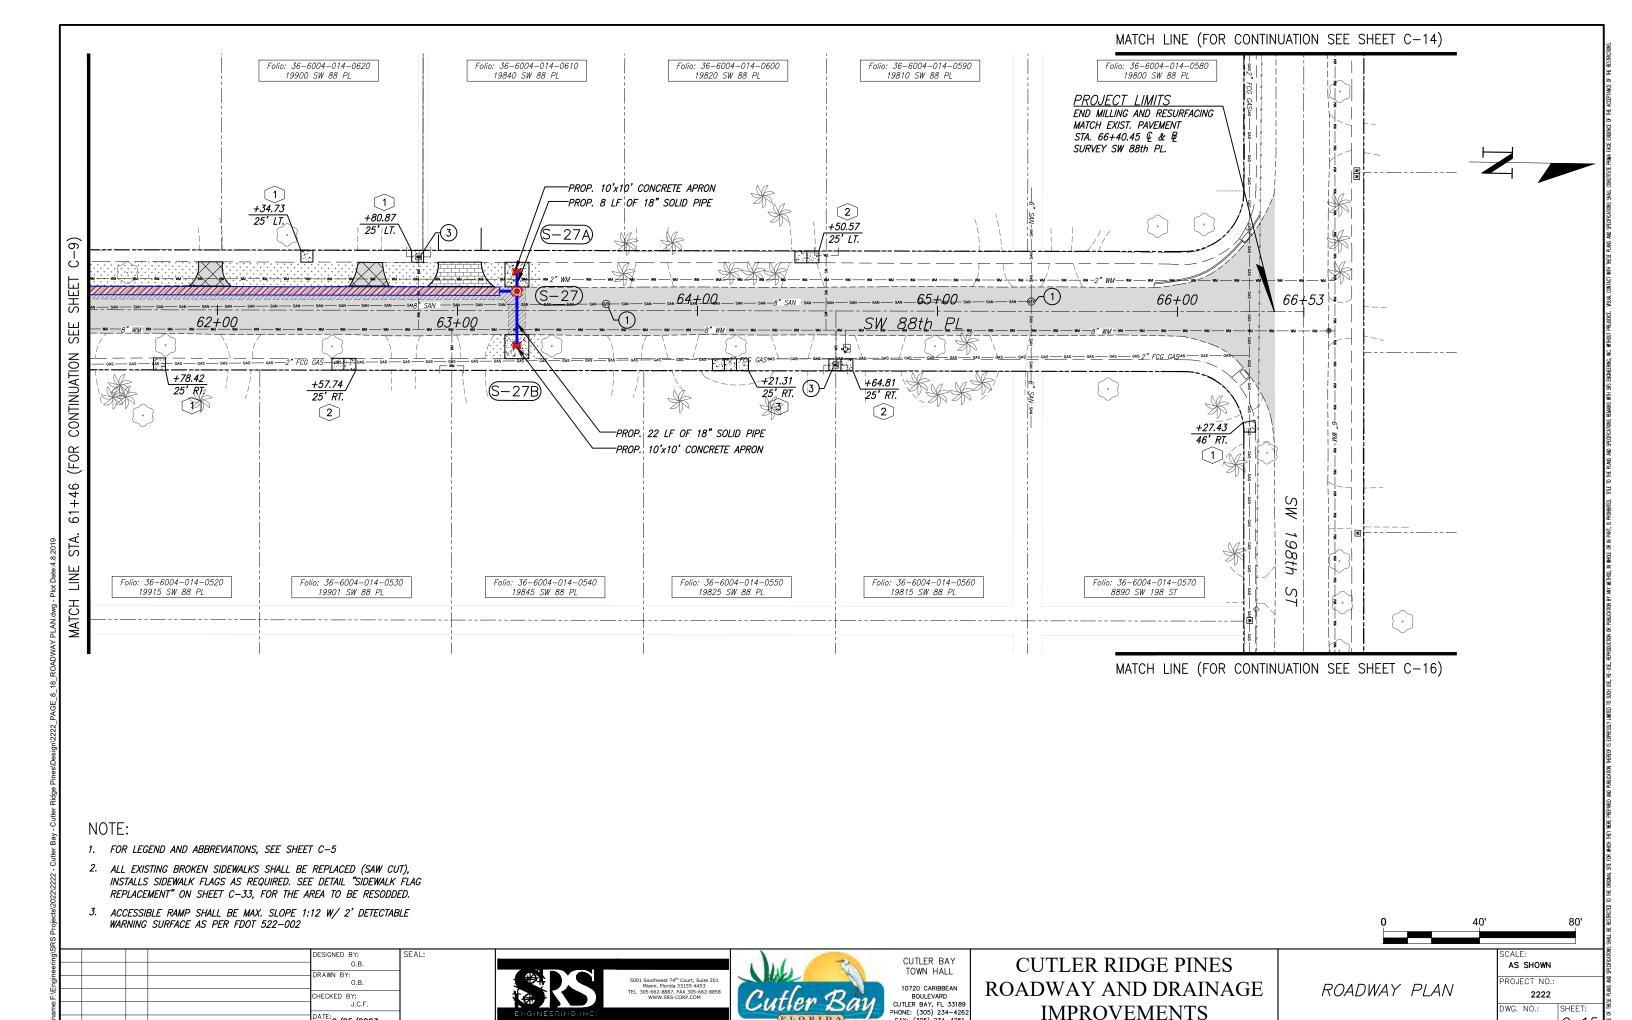

ATE: 9/25/2023

DESCRIPTION

REV. DATE BY:

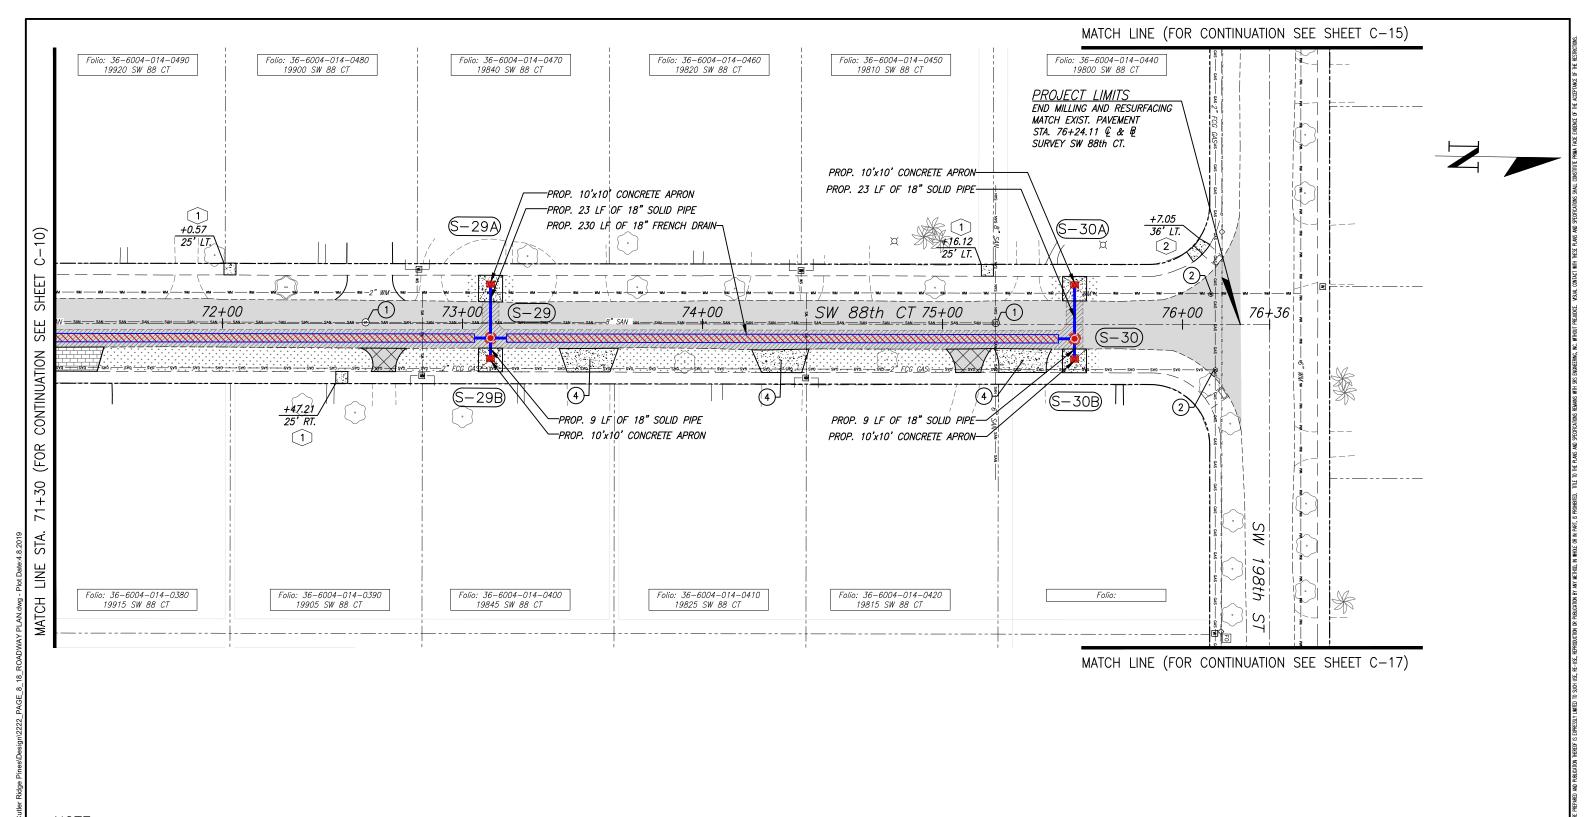

NOTE:

- 1. FOR LEGEND AND ABBREVIATIONS, SEE SHEET C-5
- 2. ALL EXISTING BROKEN SIDEWALKS SHALL BE REPLACED (SAW CUT), INSTALLS SIDEWALK FLAGS AS REQUIRED. SEE DETAIL "SIDEWALK FLAG REPLACEMENT" ON SHEET C-33, FOR THE AREA TO BE RESODDED.
- 3. ACCESSIBLE RAMP SHALL BE MAX. SLOPE 1:12 W/ 2' DETECTABLE WARNING SURFACE AS PER FDOT 522-002

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CUTLER BAY
TOWN HALL


10720 CARIBBEAN
BOULEVARD
CUTLER BAY, FL 33189
PHONE: (305) 234-4262
FAX: (305) 234-4251

CUTLER RIDGE PINES ROADWAY AND DRAINAGE IMPROVEMENTS ROADWAY PLAN

ROADWAY PLAN

PROJECT NO.
2222

DWG. NO.:

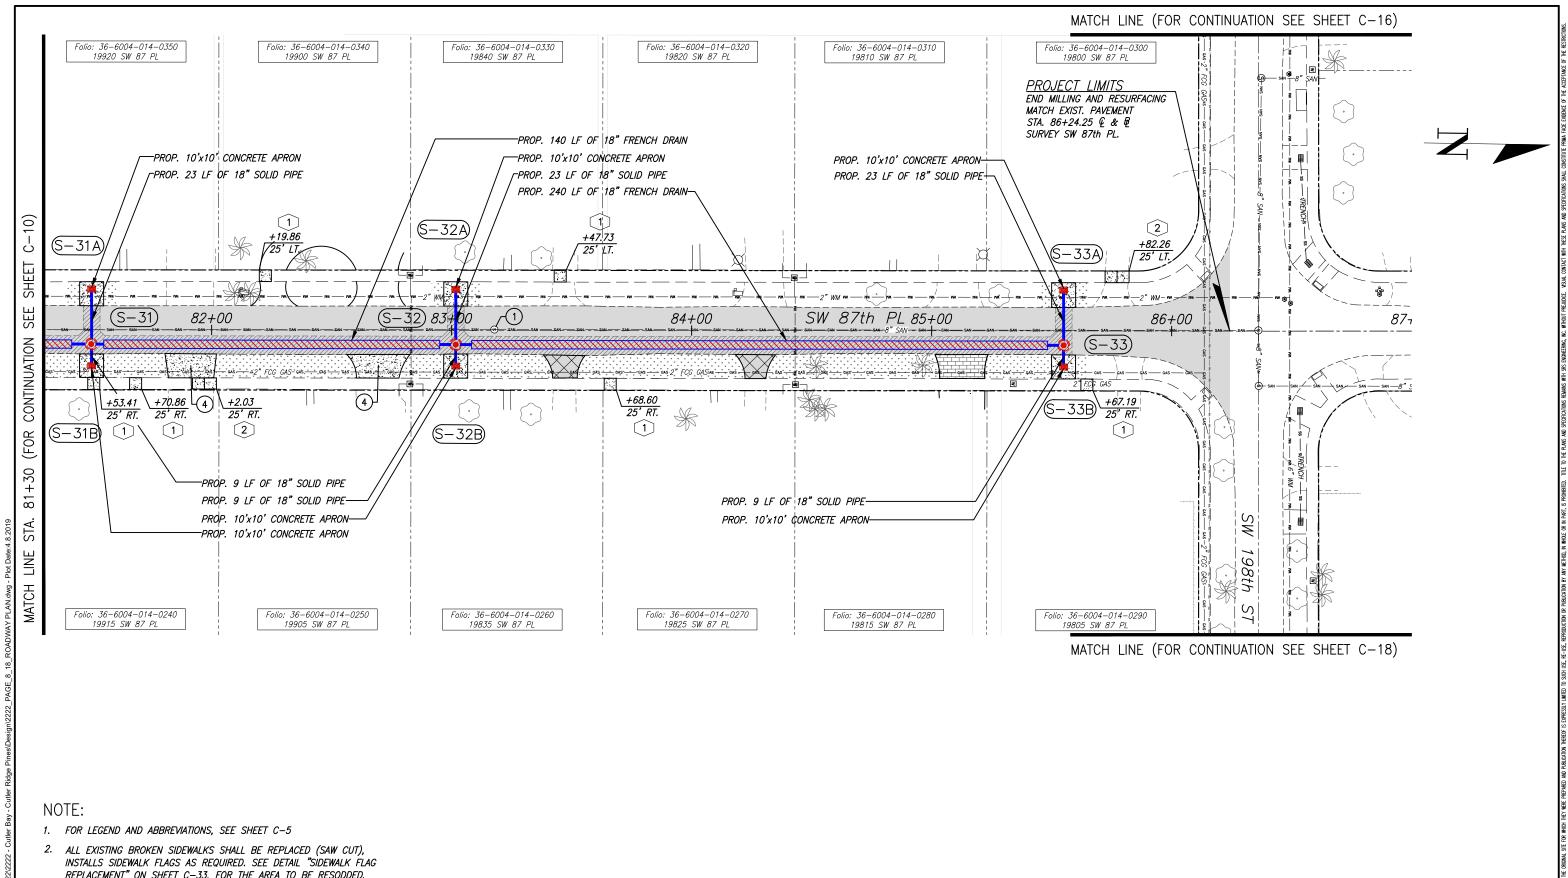

- REPLACEMENT" ON SHEET C-33, FOR THE AREA TO BE RESODDED.
- ACCESSIBLE RAMP SHALL BE MAX. SLOPE 1:12 W/ 2' DETECTABLE WARNING SURFACE AS PER FDOT 522-002

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^{E:} 9/25/2023	
	O.B. WN BY: O.B. CKED BY: J.C.F. E: 9/25/2023








CUTLER BAY TOWN HALL 10720 CARIBBEAN BOULEVARD CUTLER BAY, FL 33189 PHONE: (305) 234-4262


CUTLER RIDGE PINES ROADWAY AND DRAINAGE **IMPROVEMENTS**


AS SHOWN PROJECT NO. ROADWAY PLAN 2222

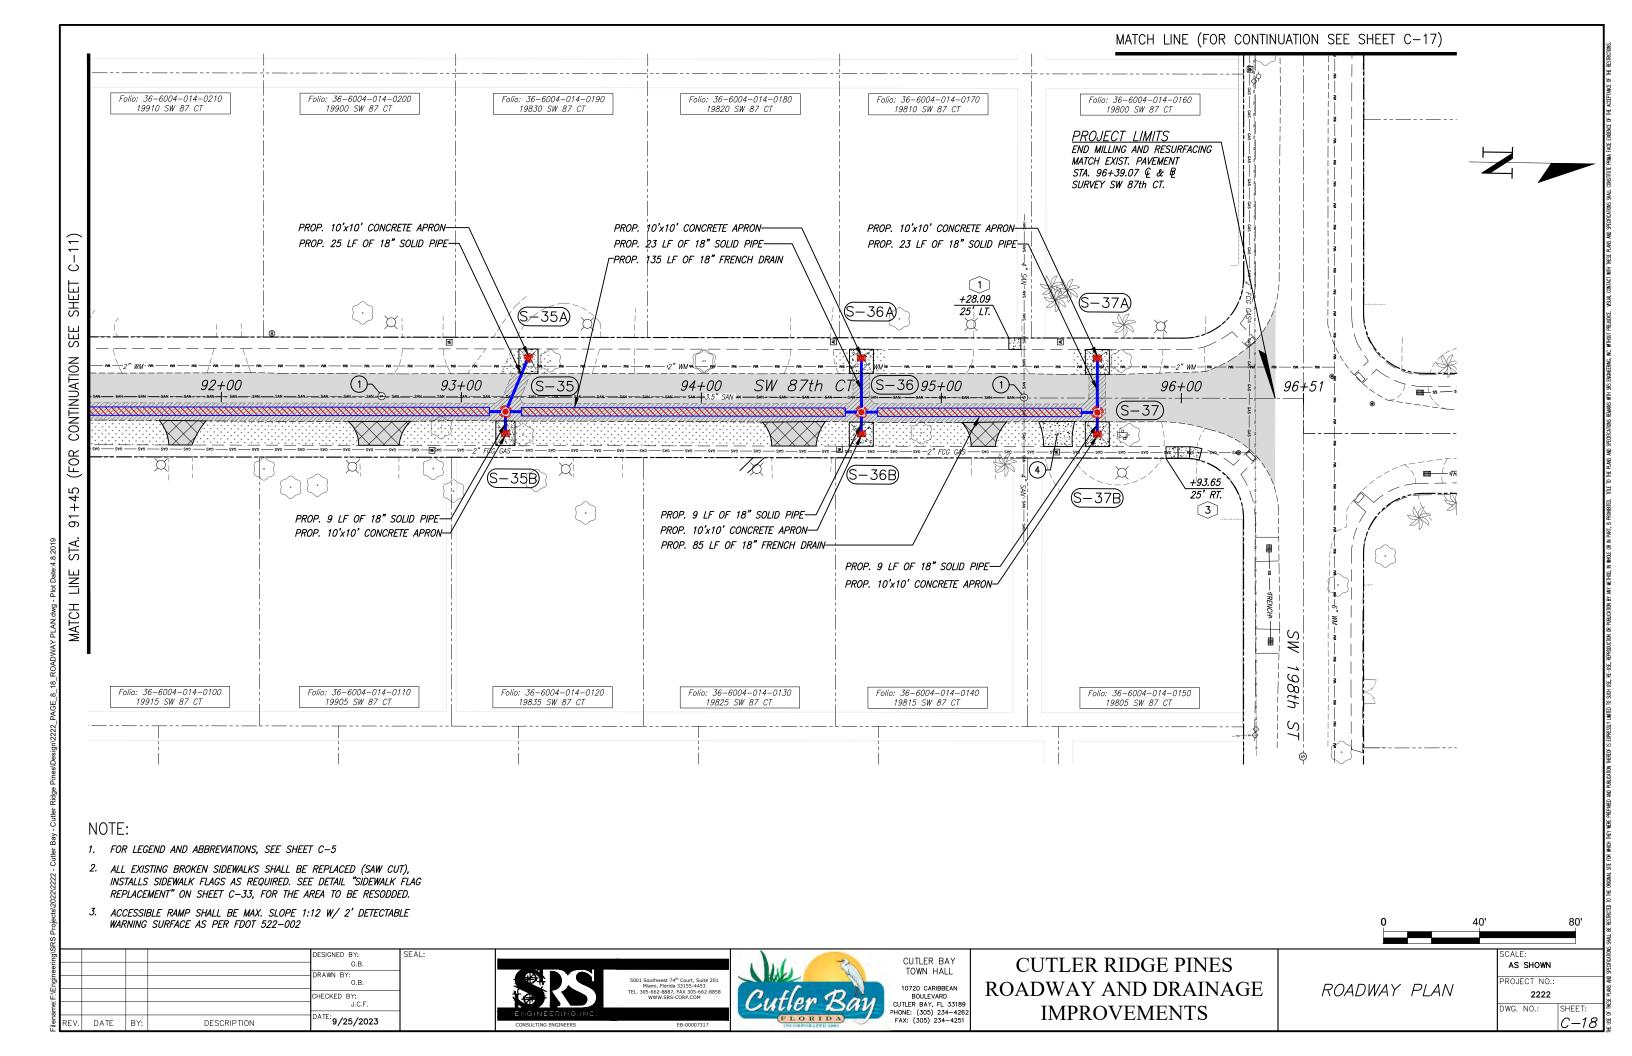


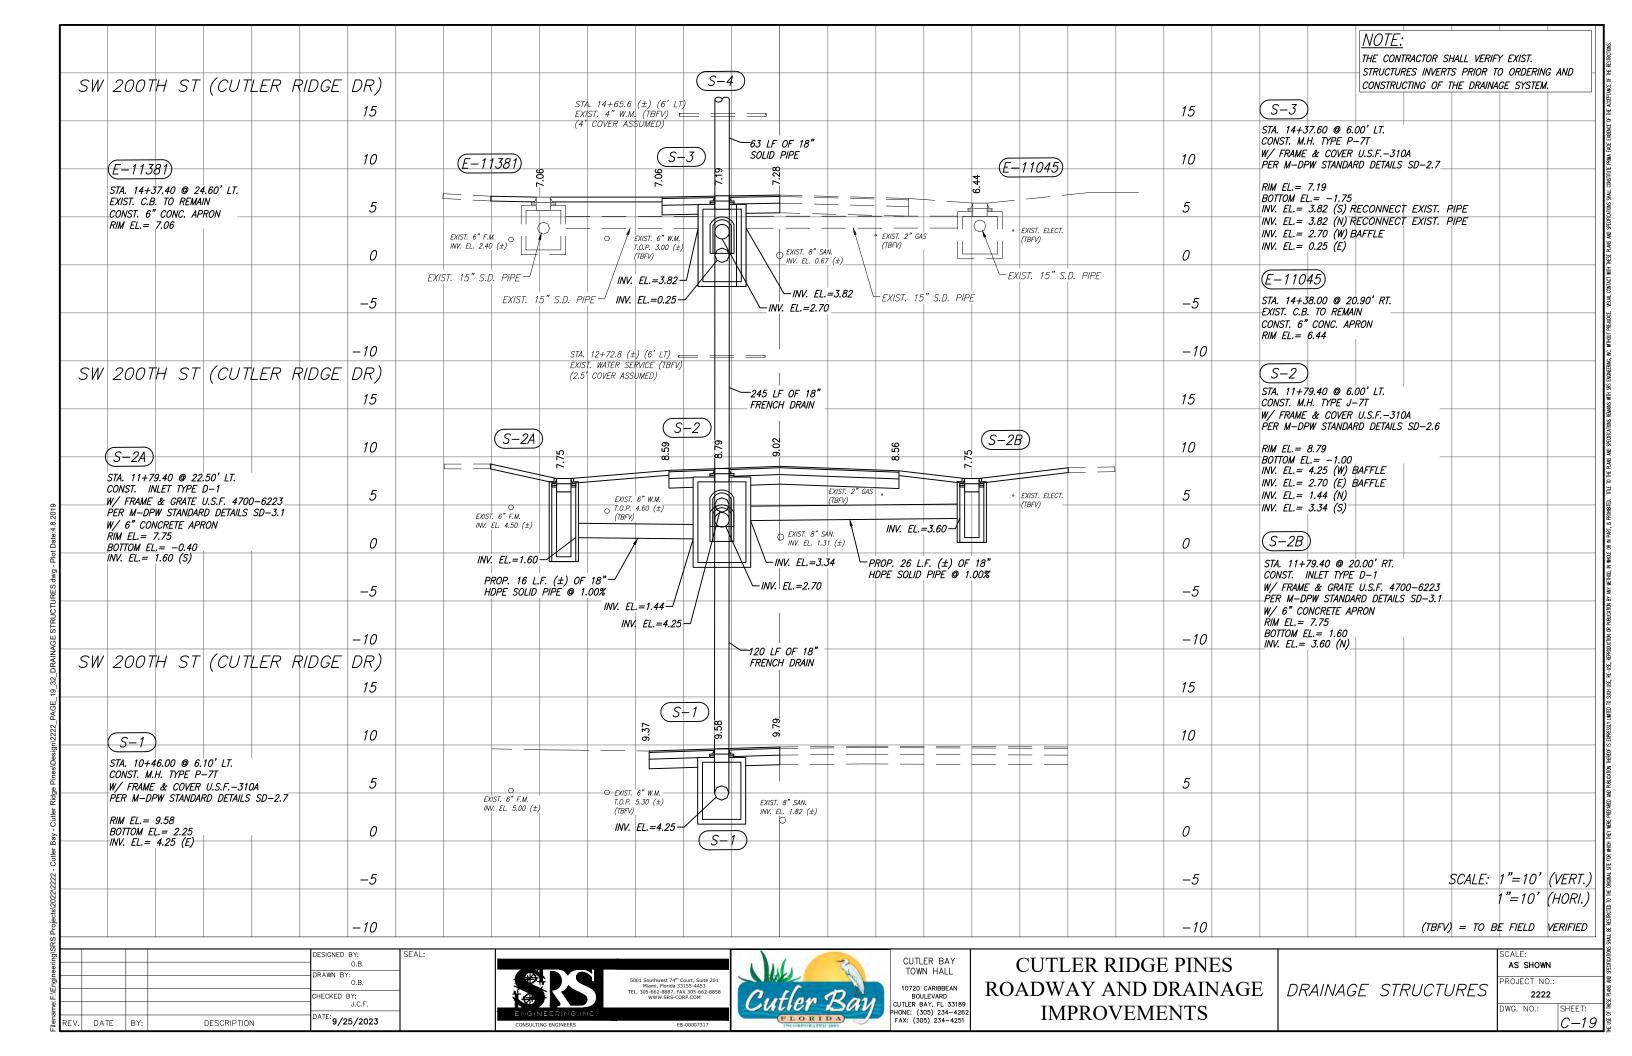


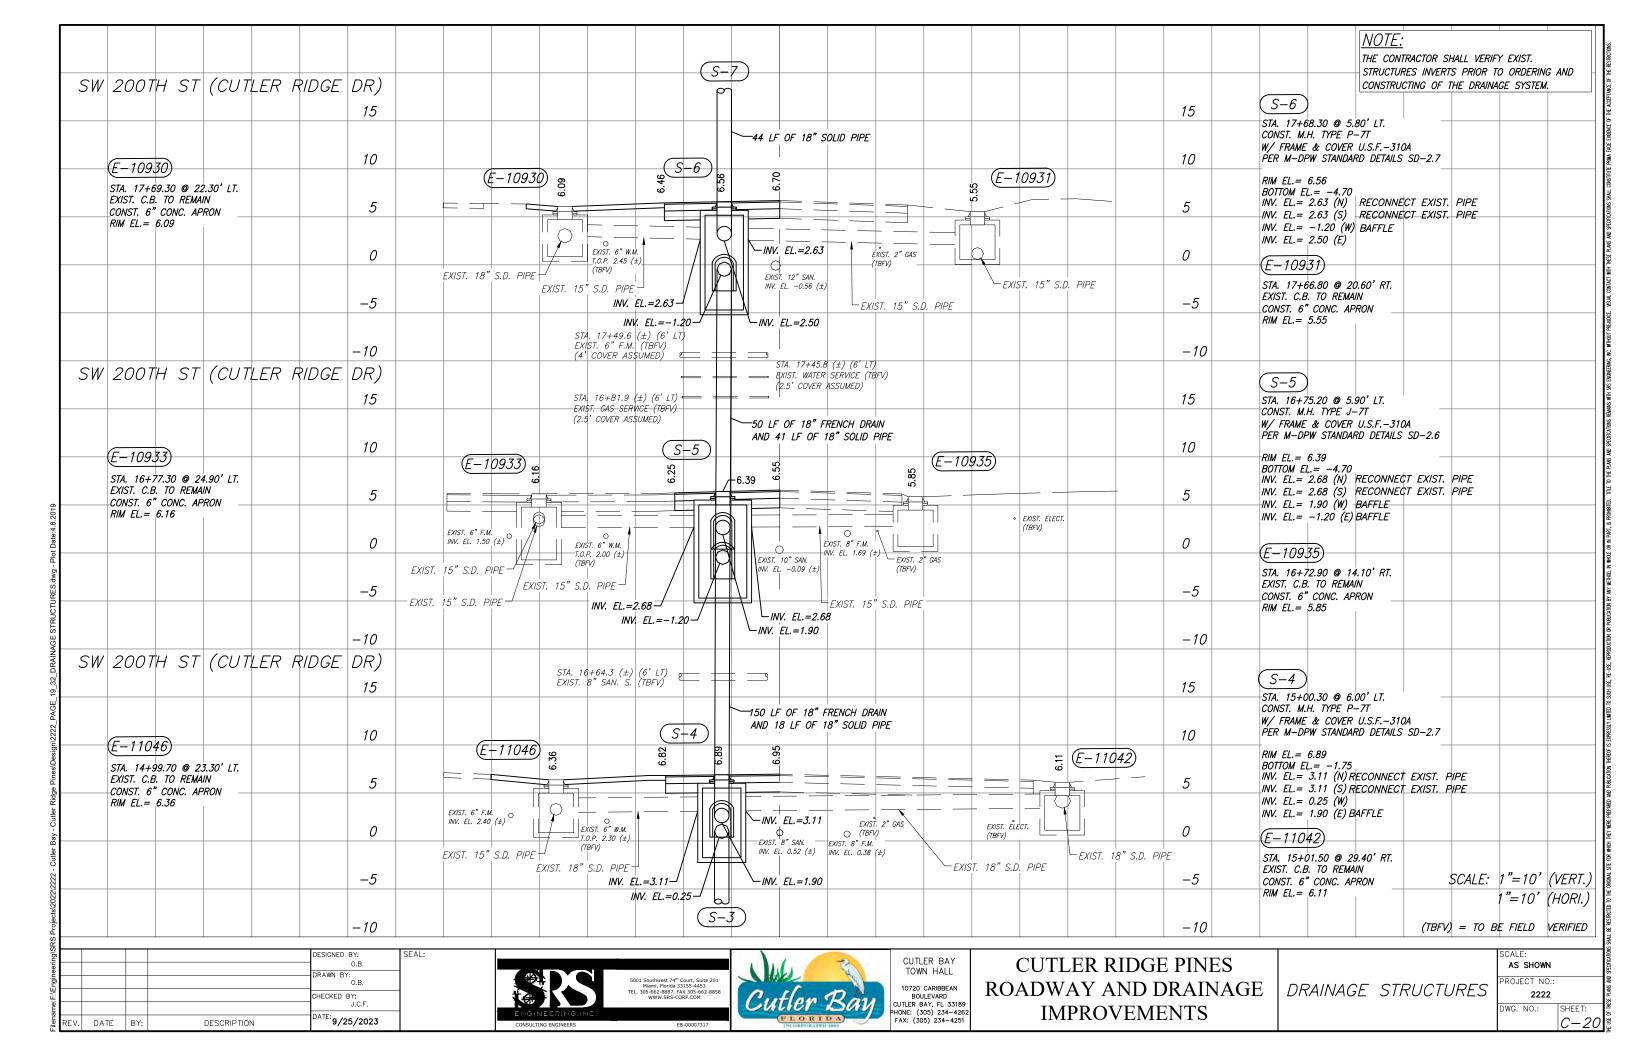


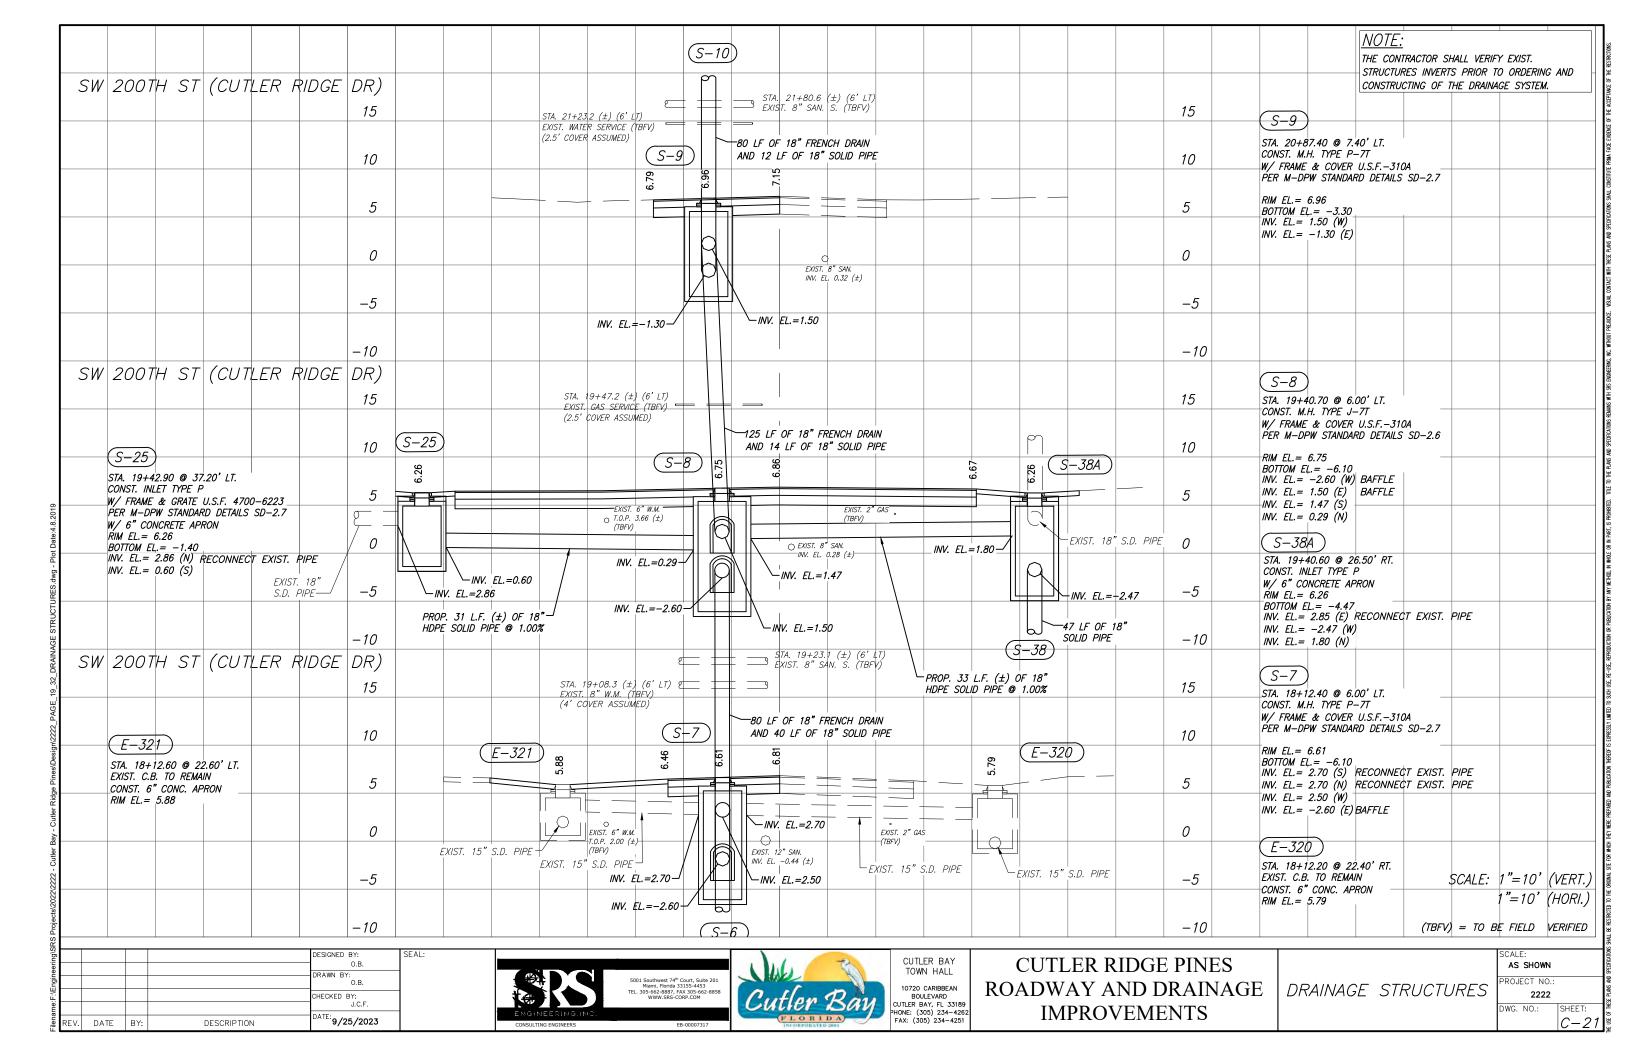


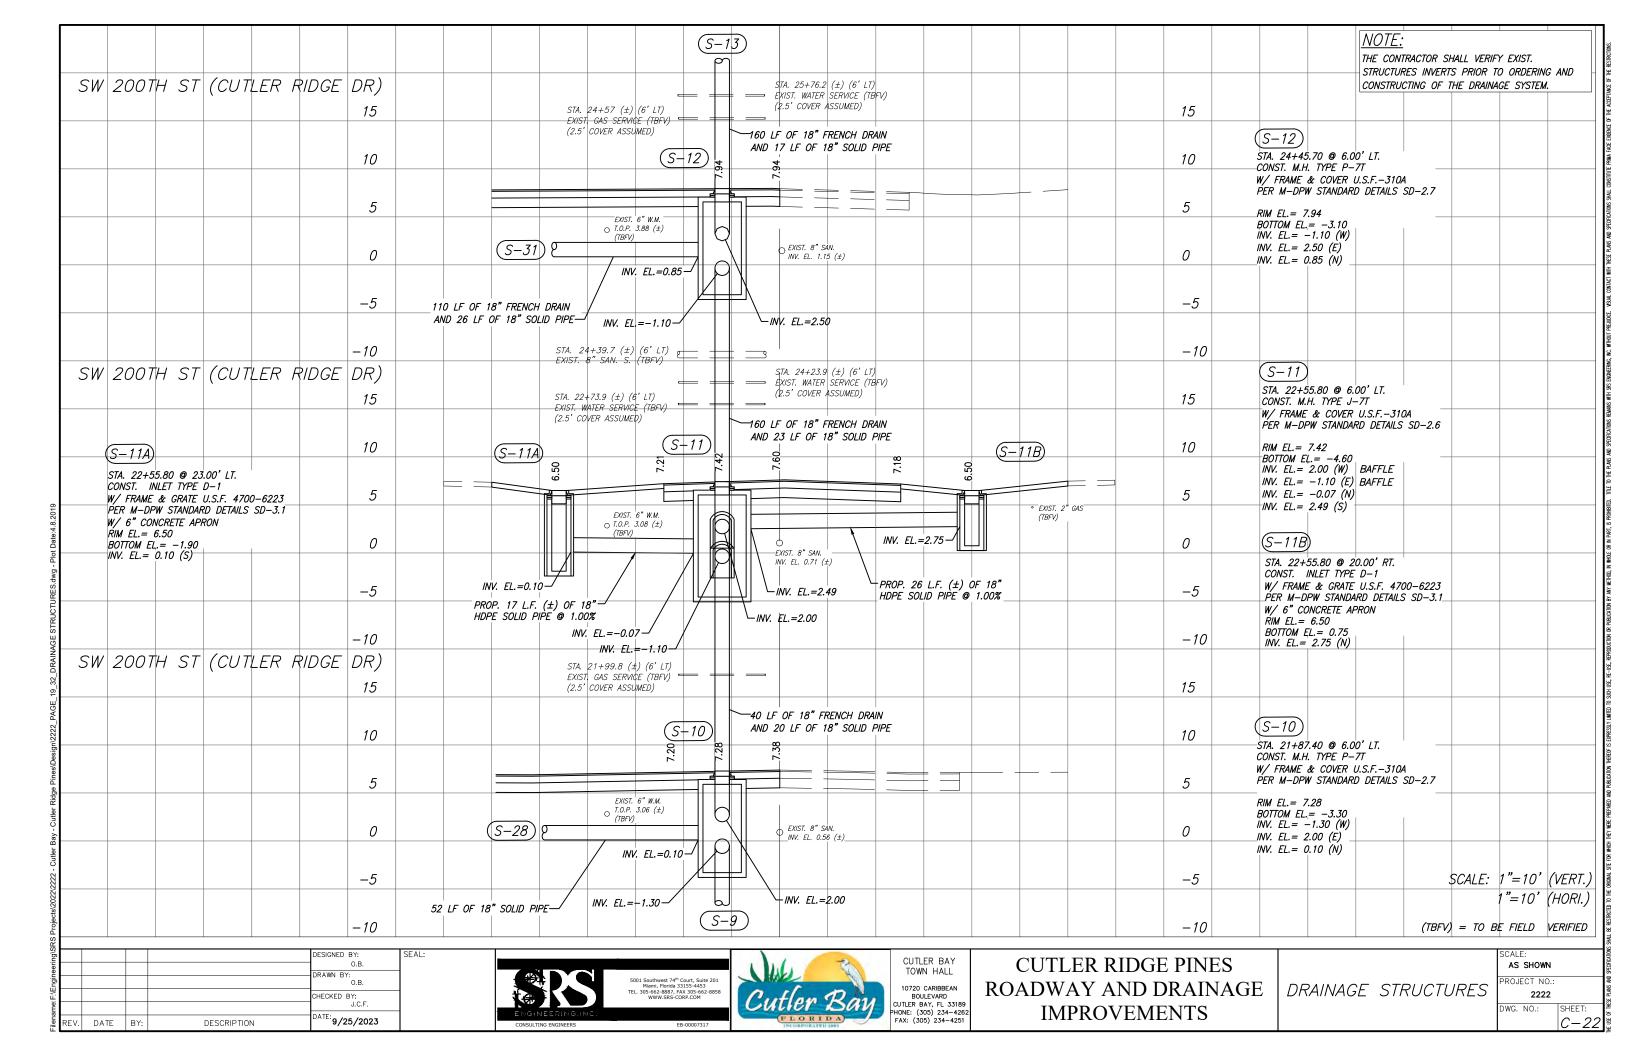


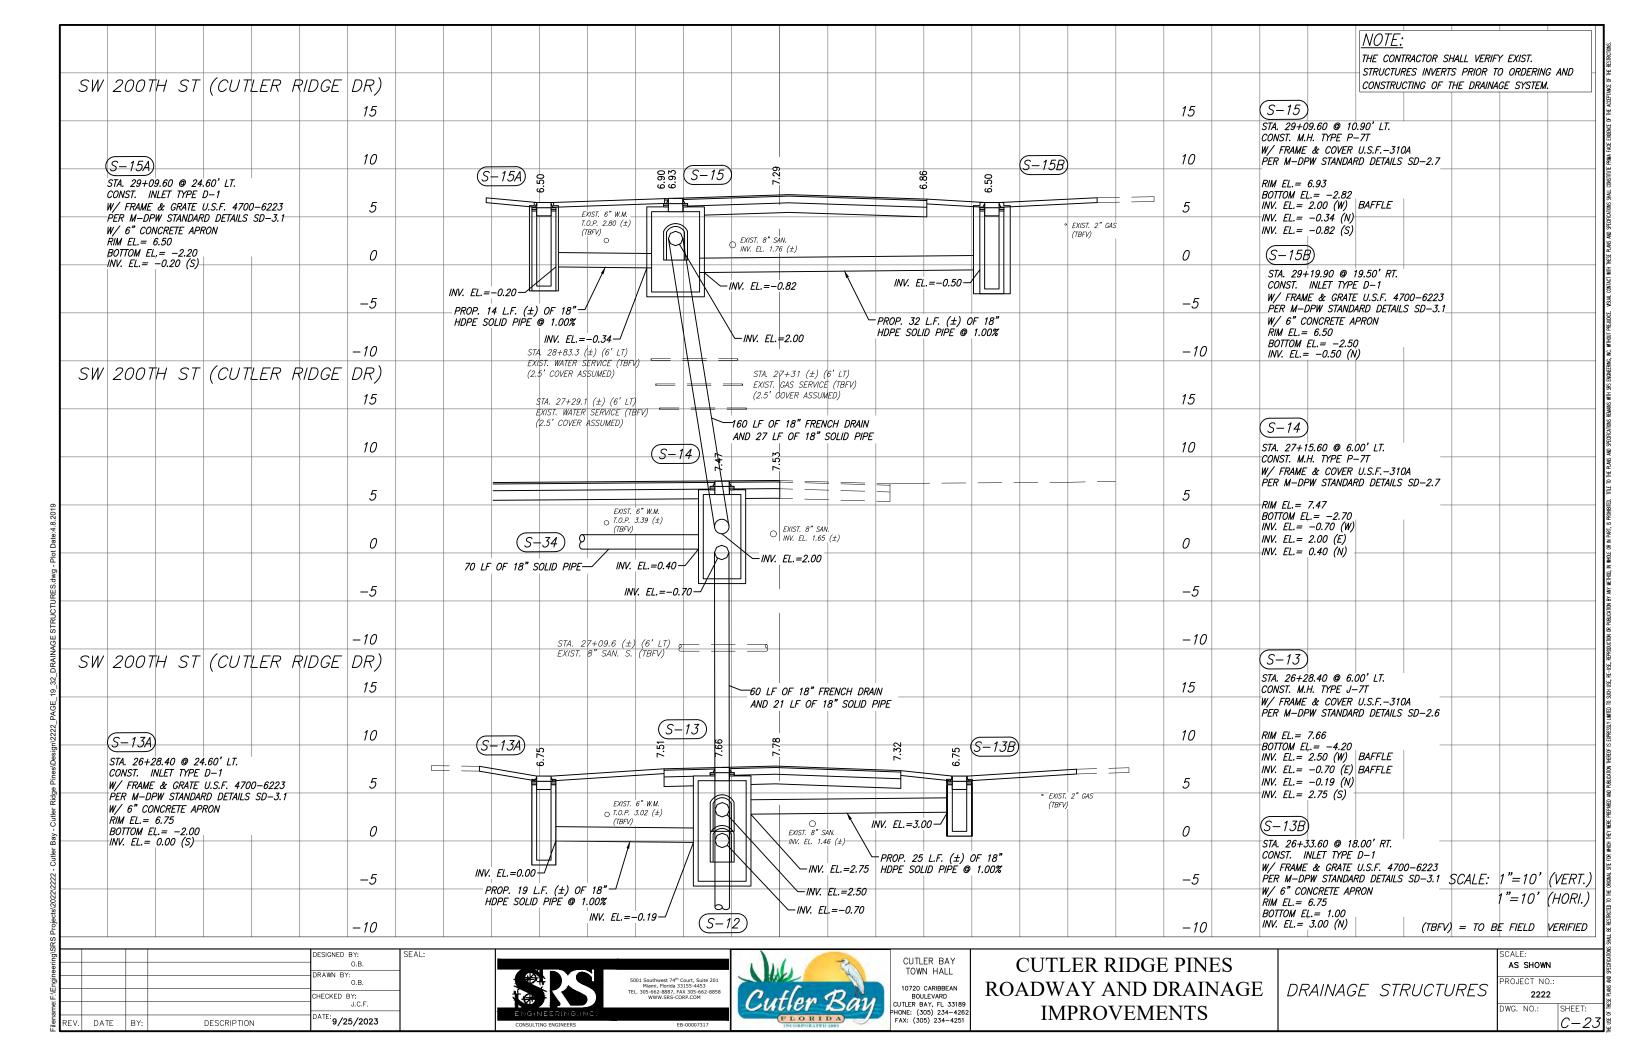


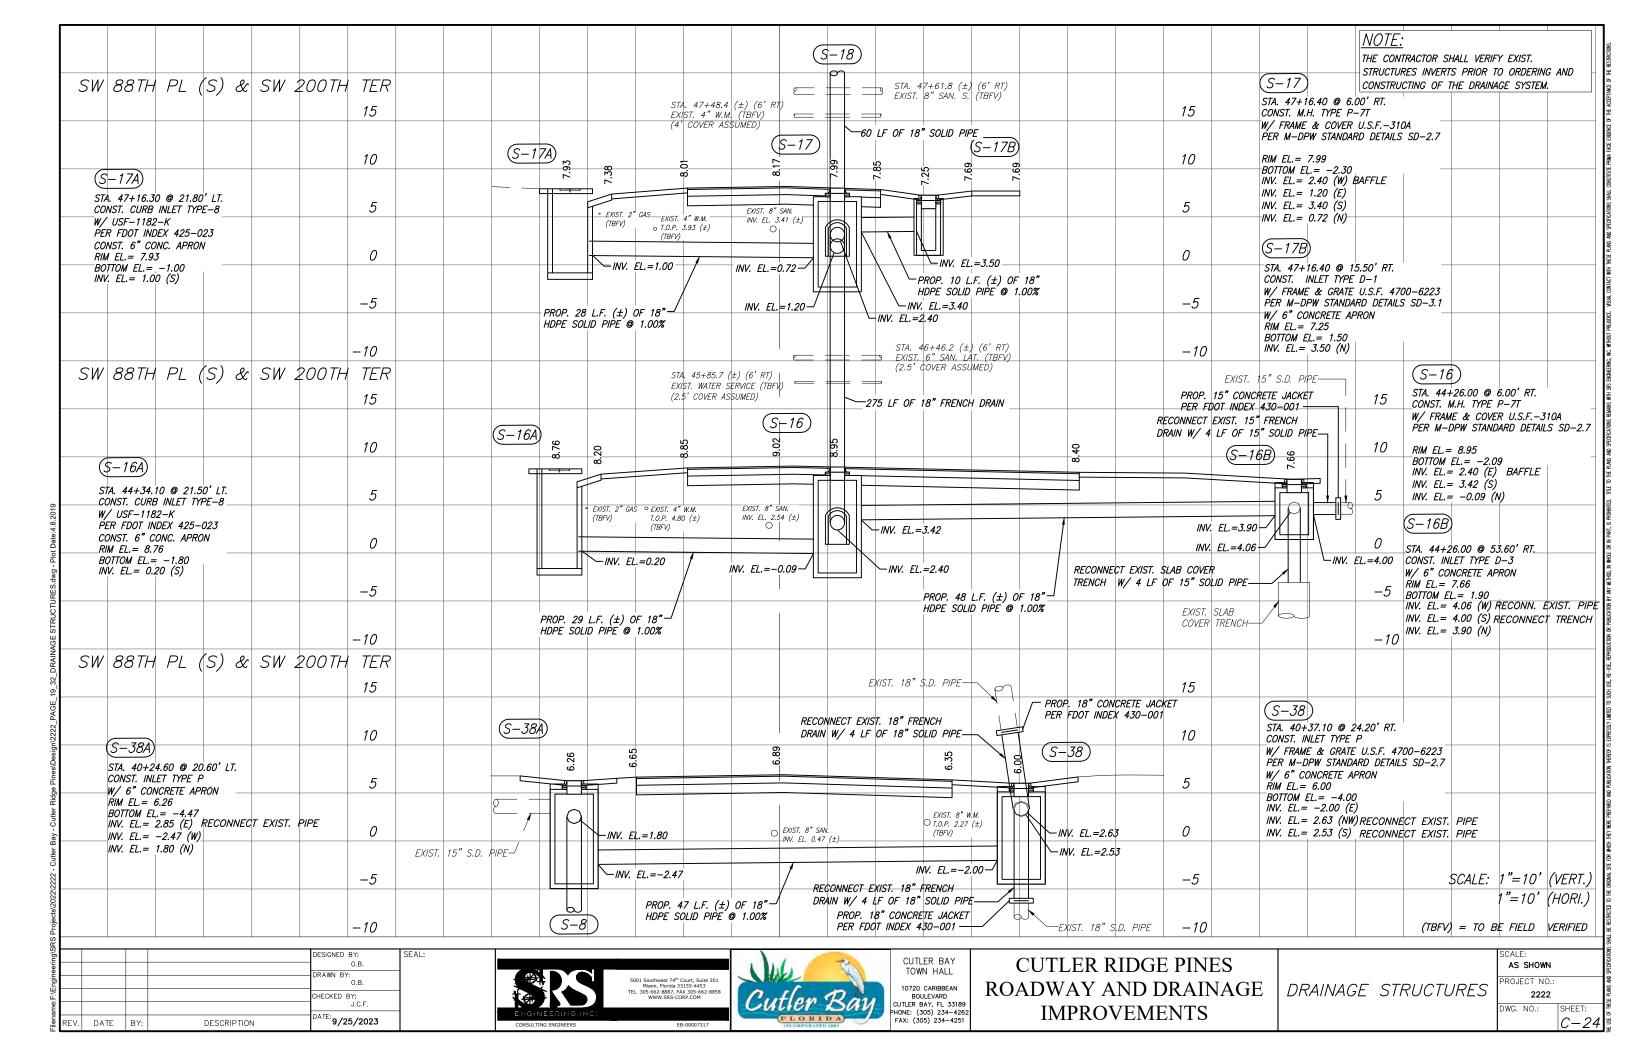


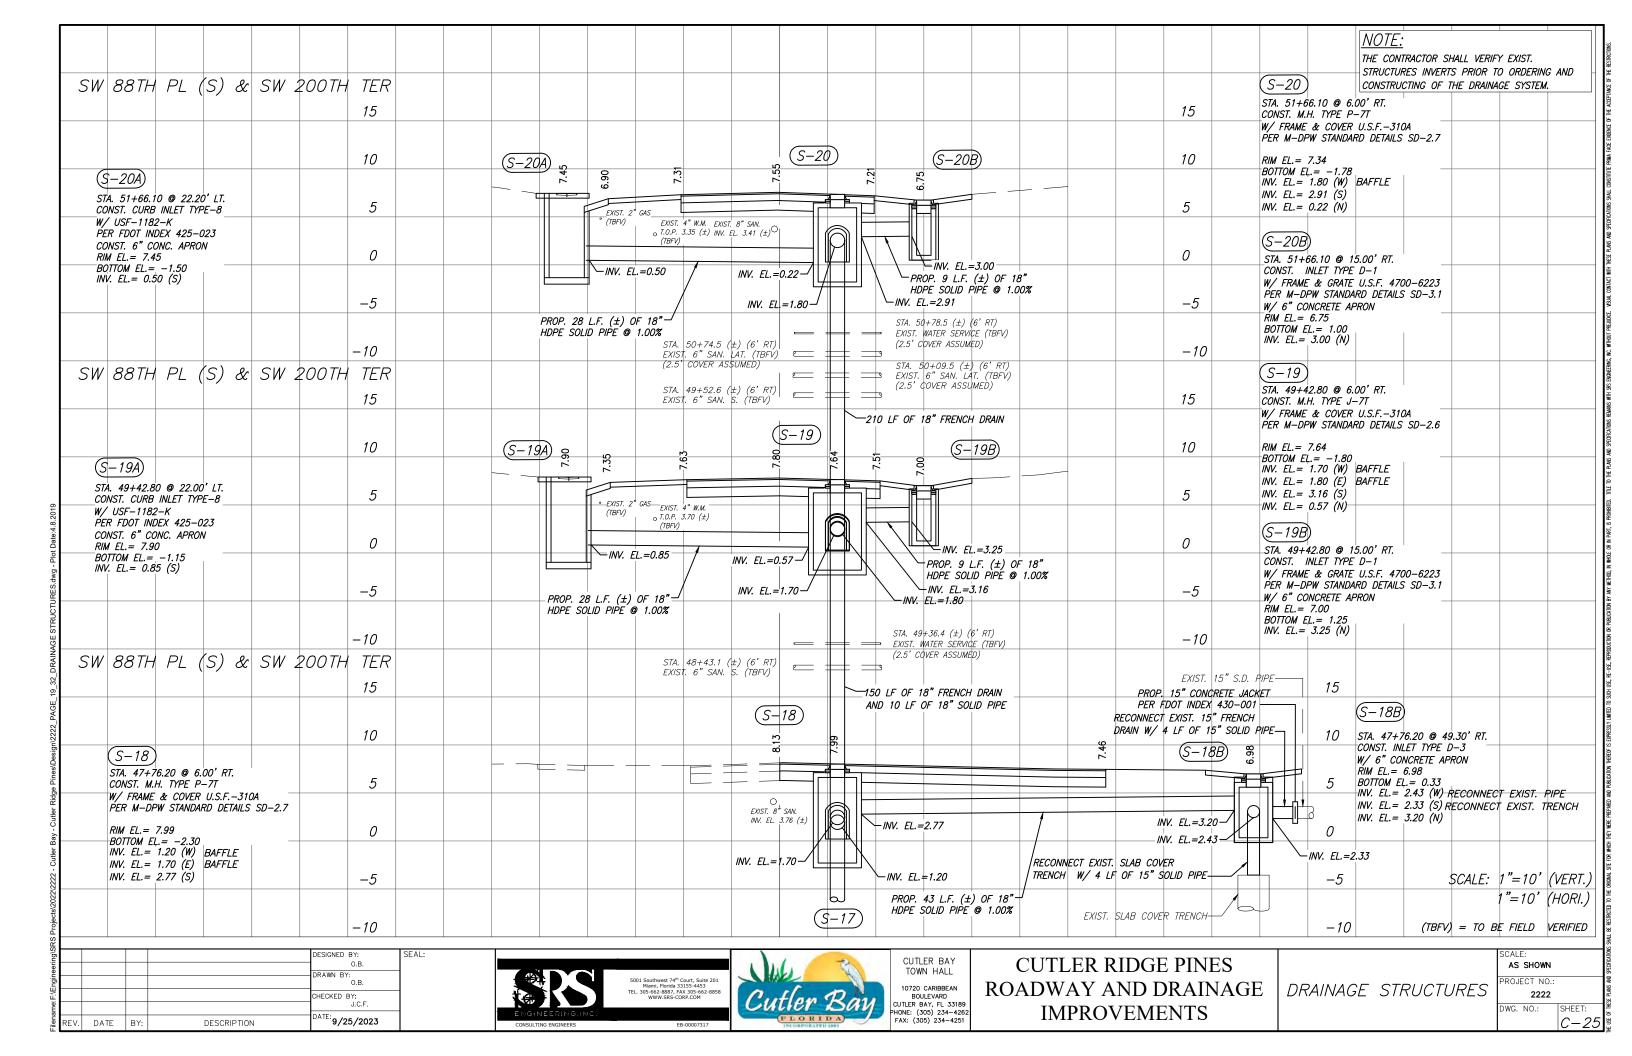


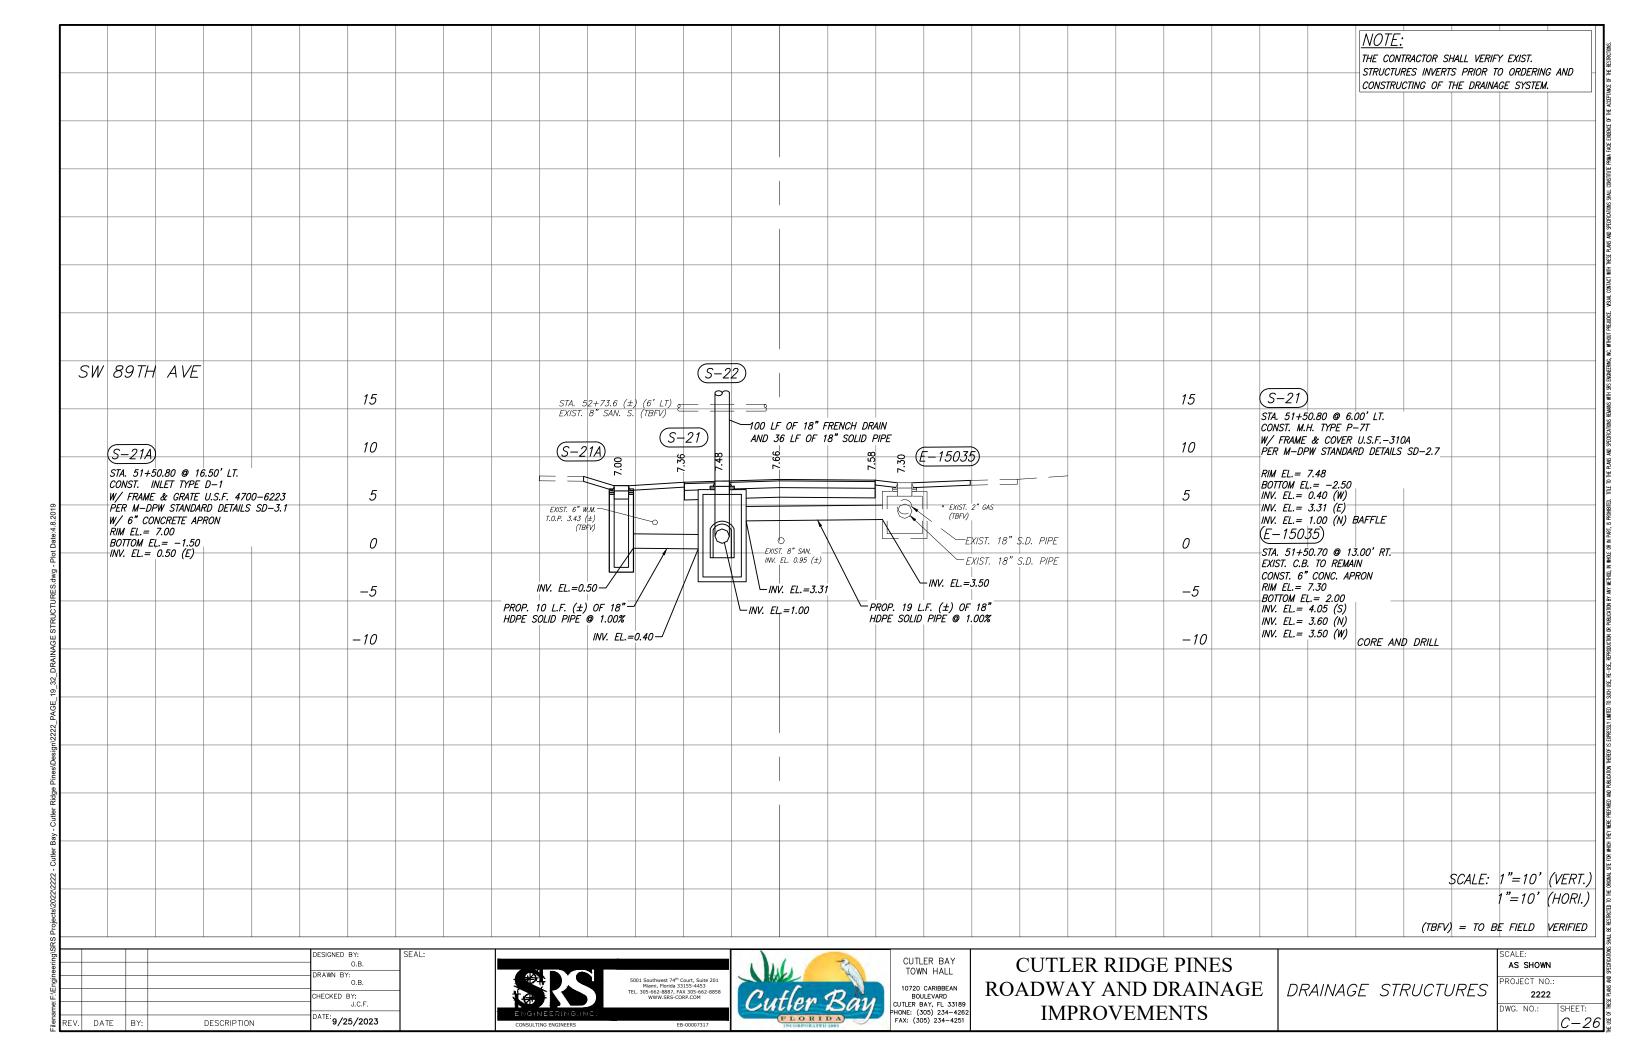


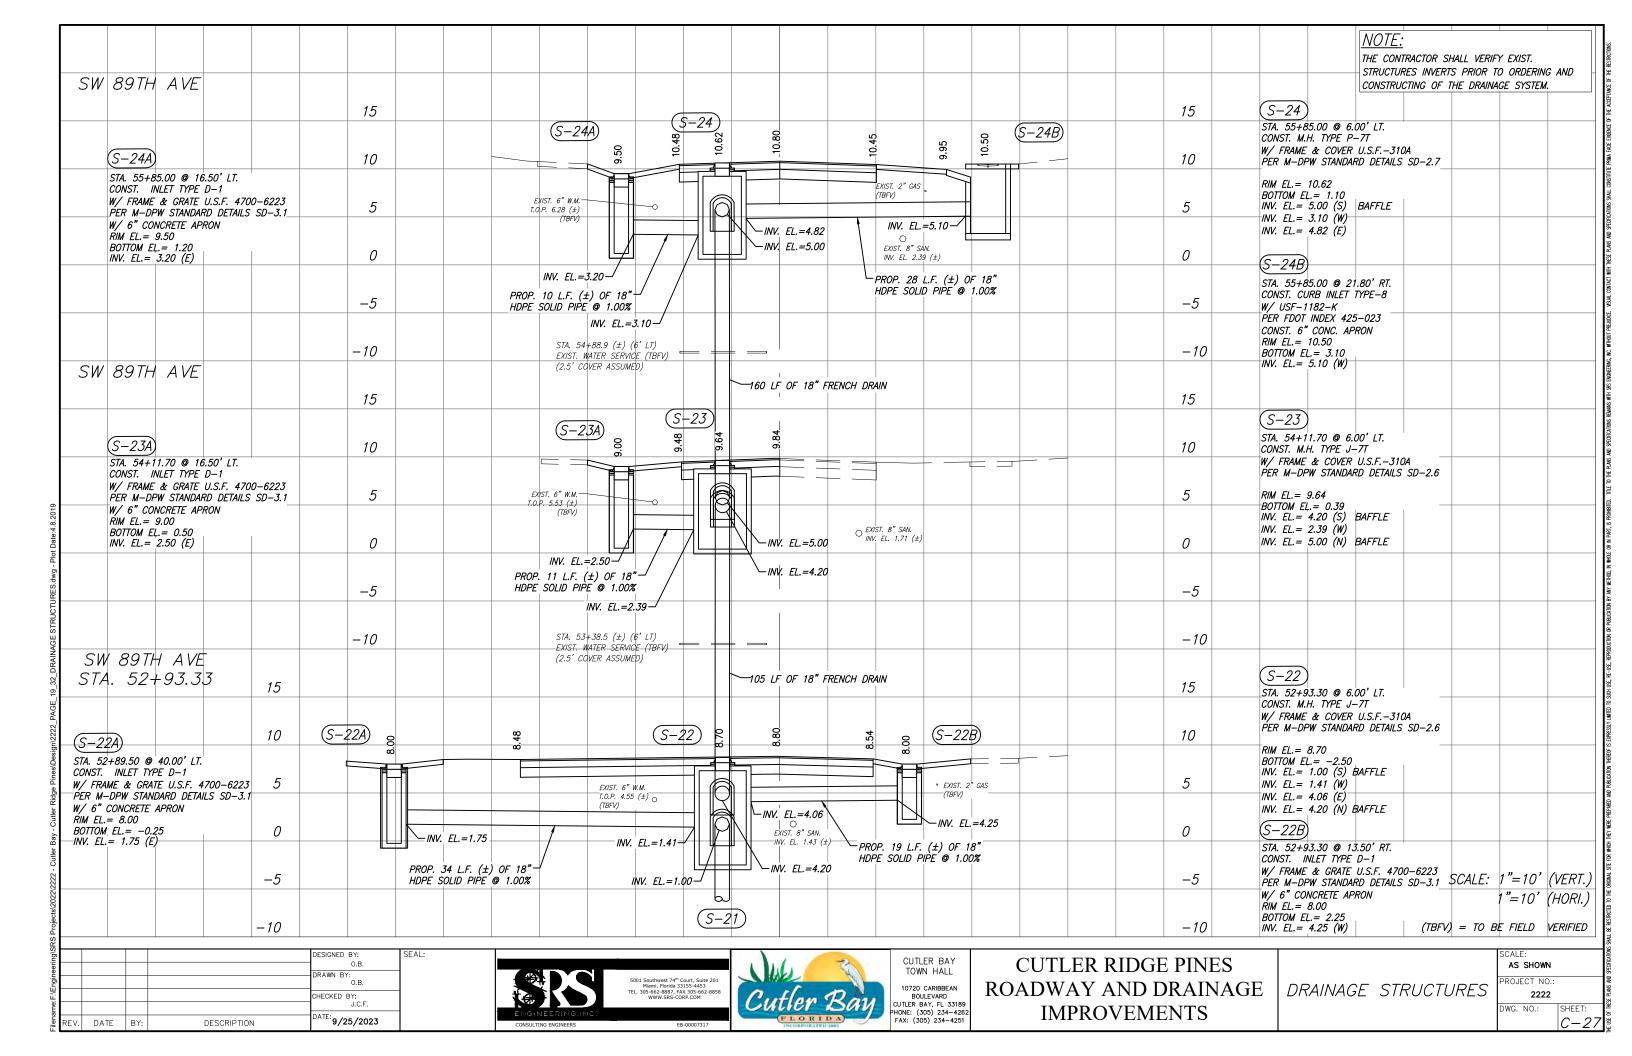


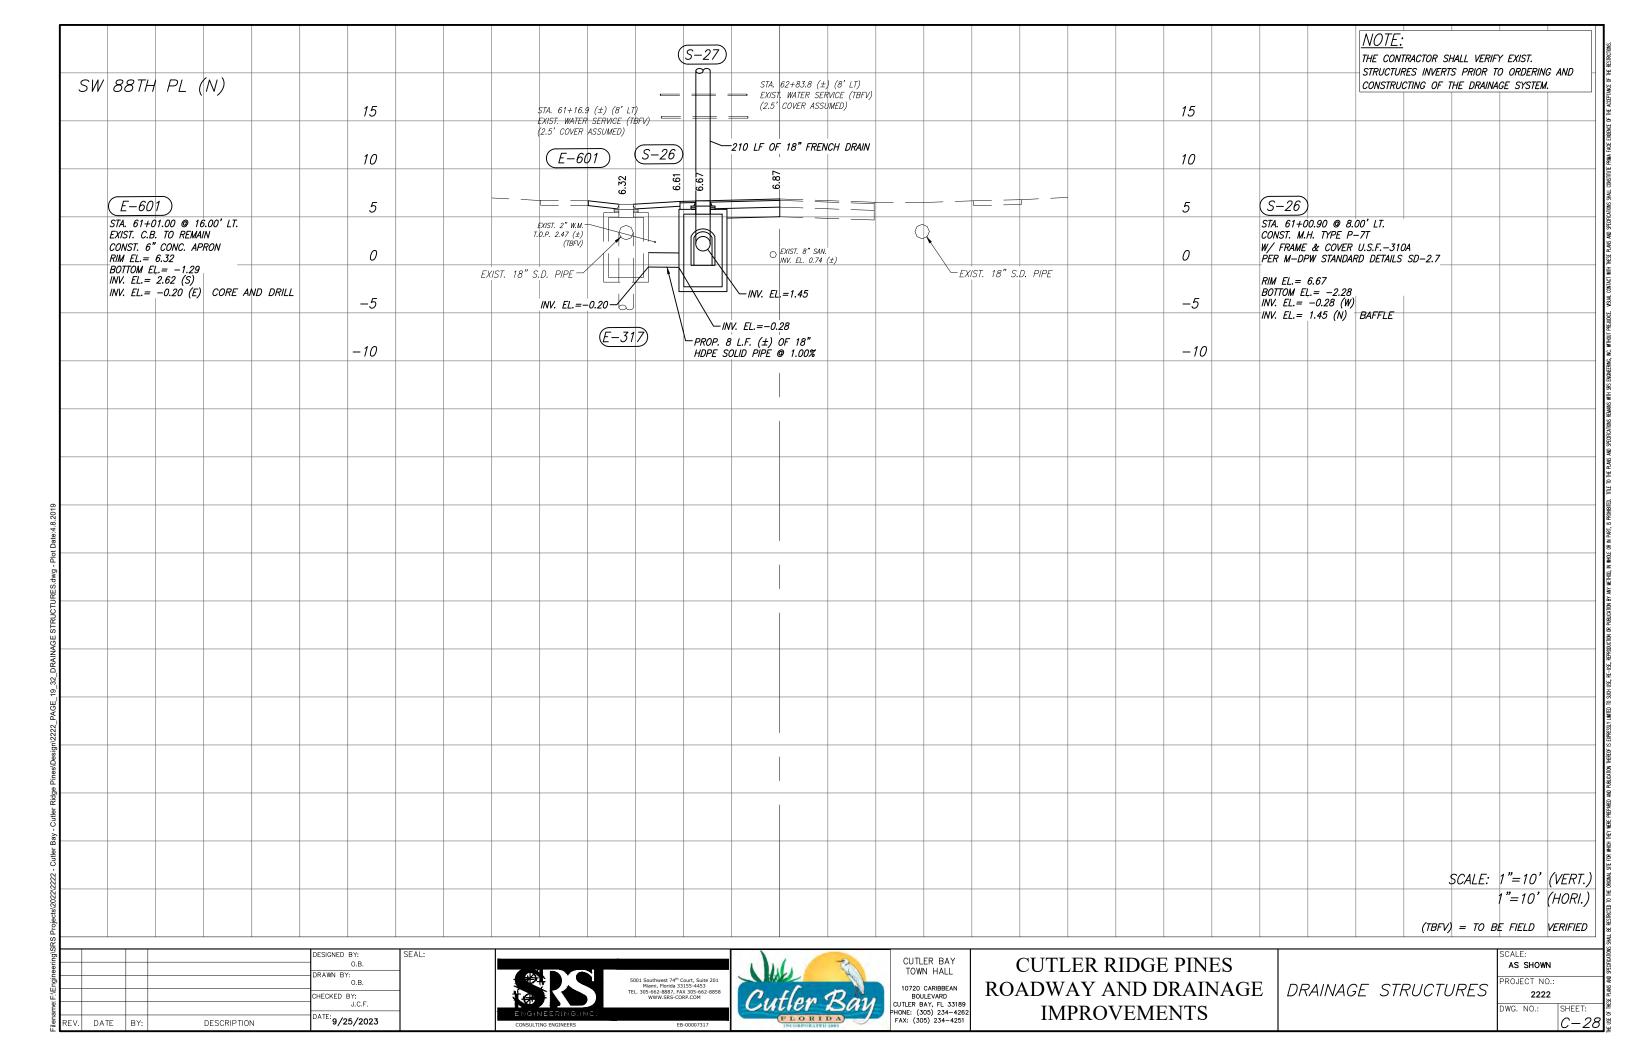


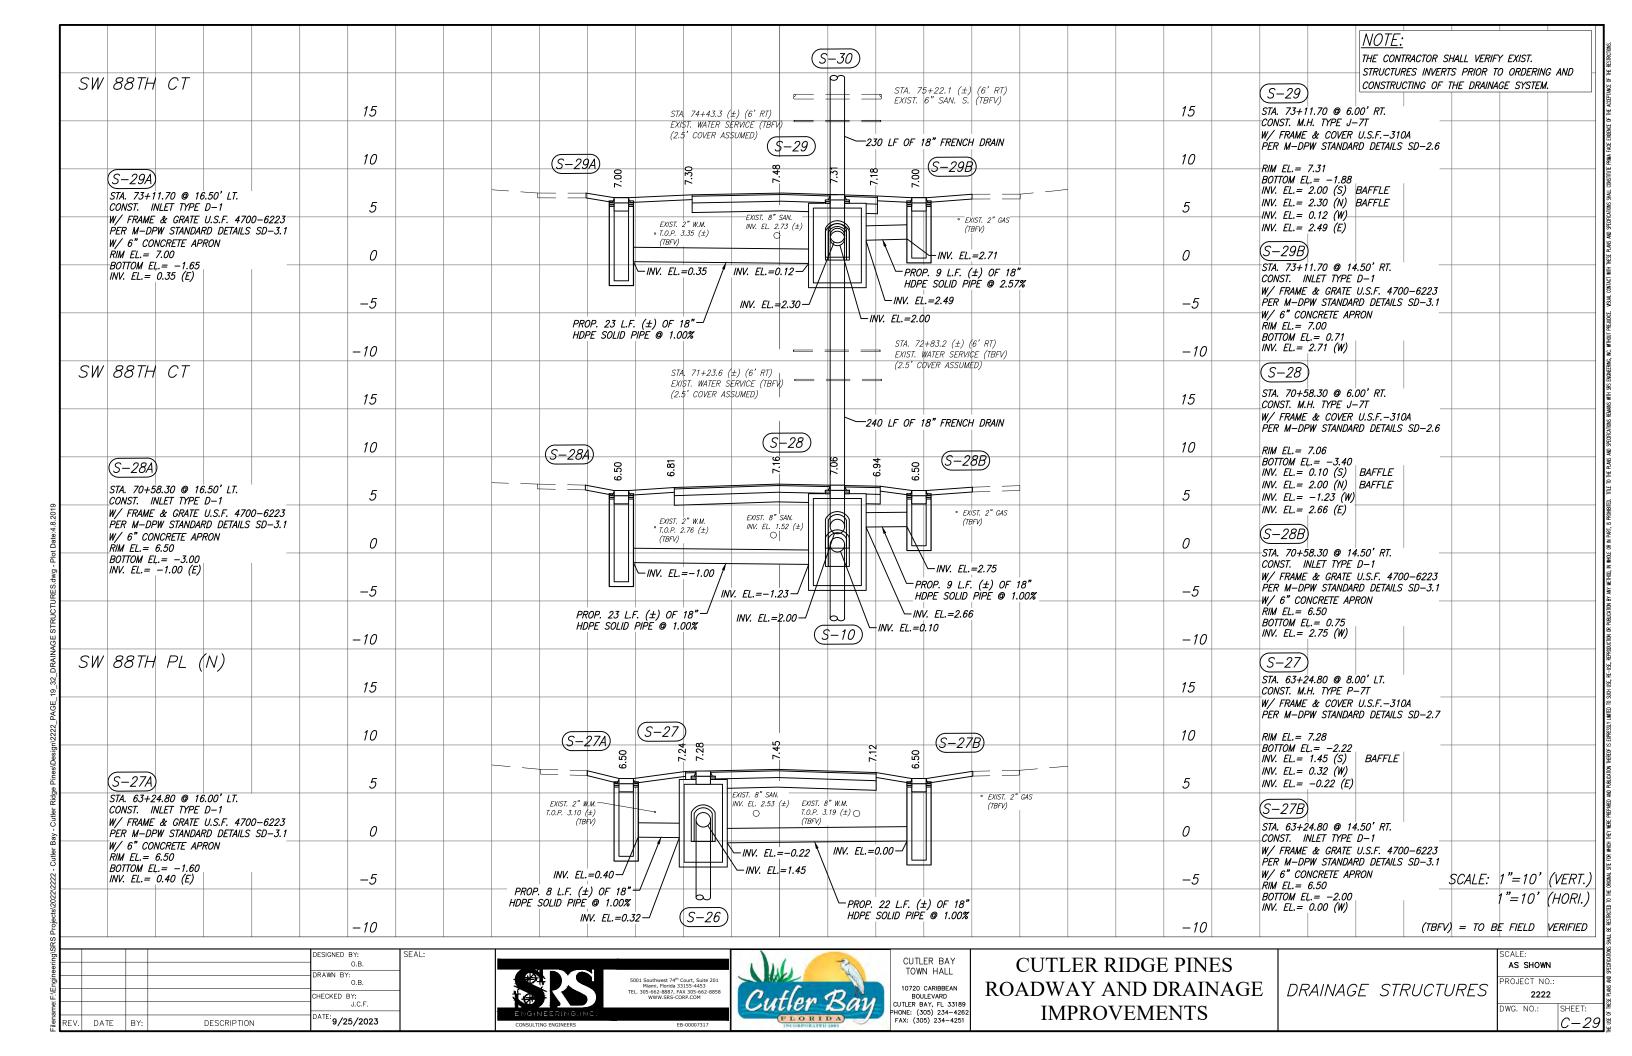


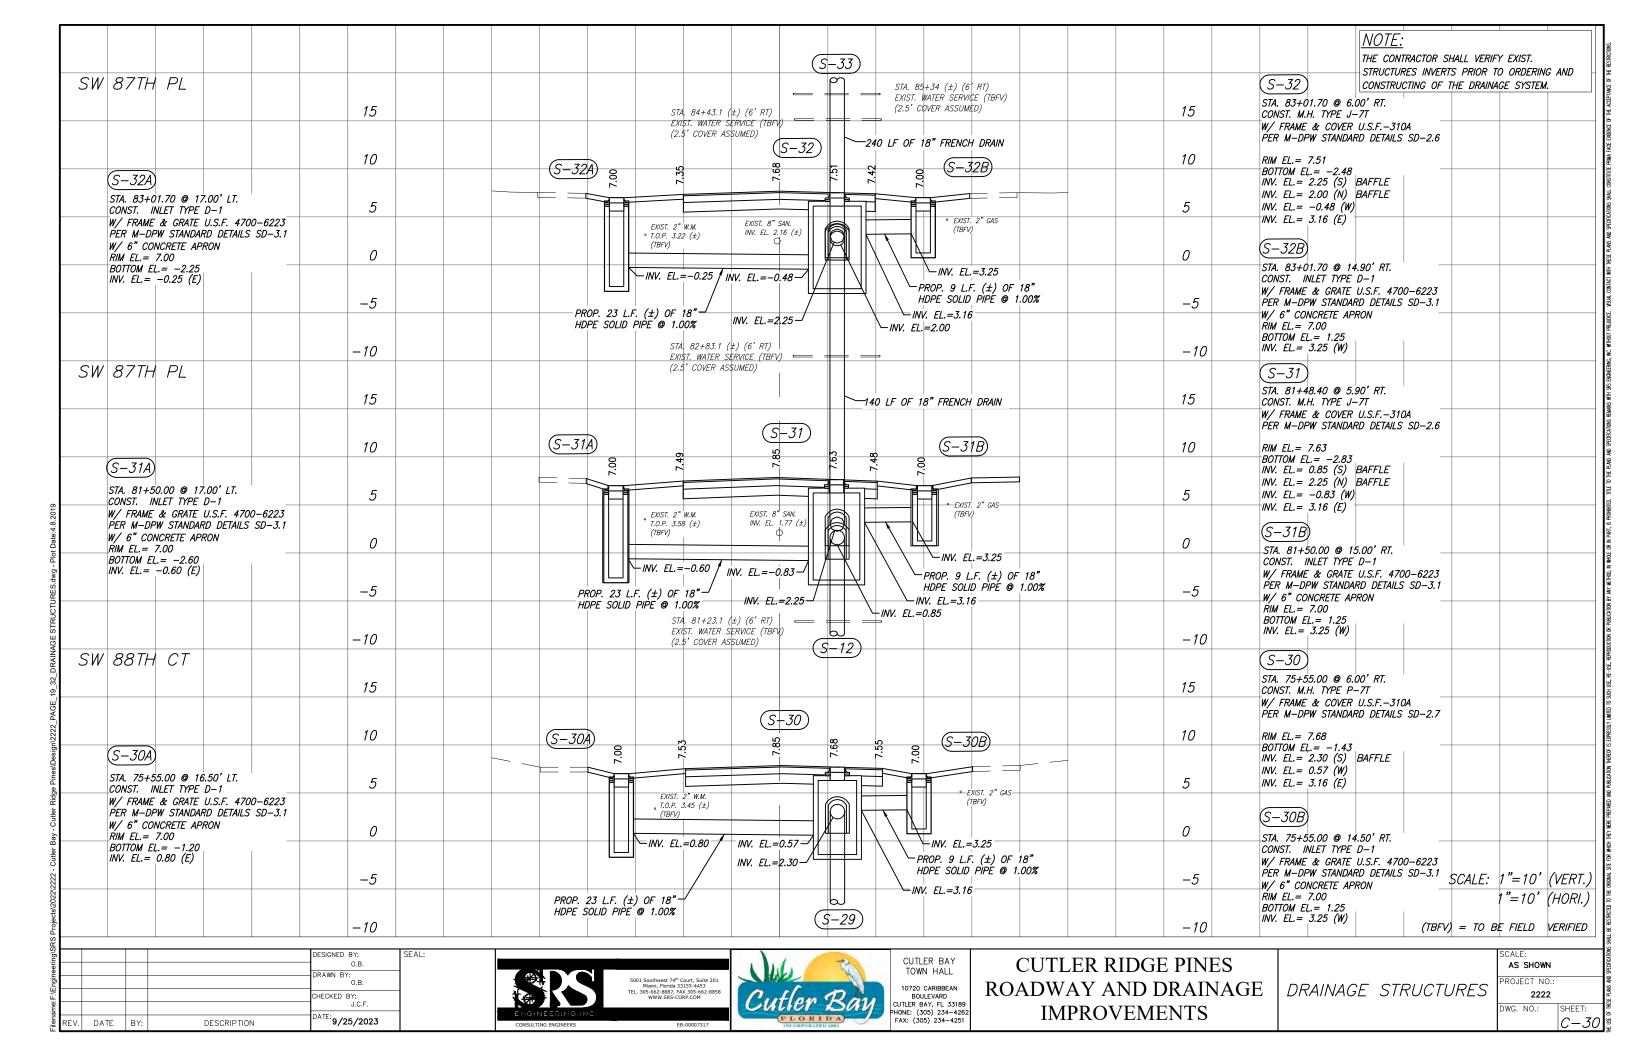

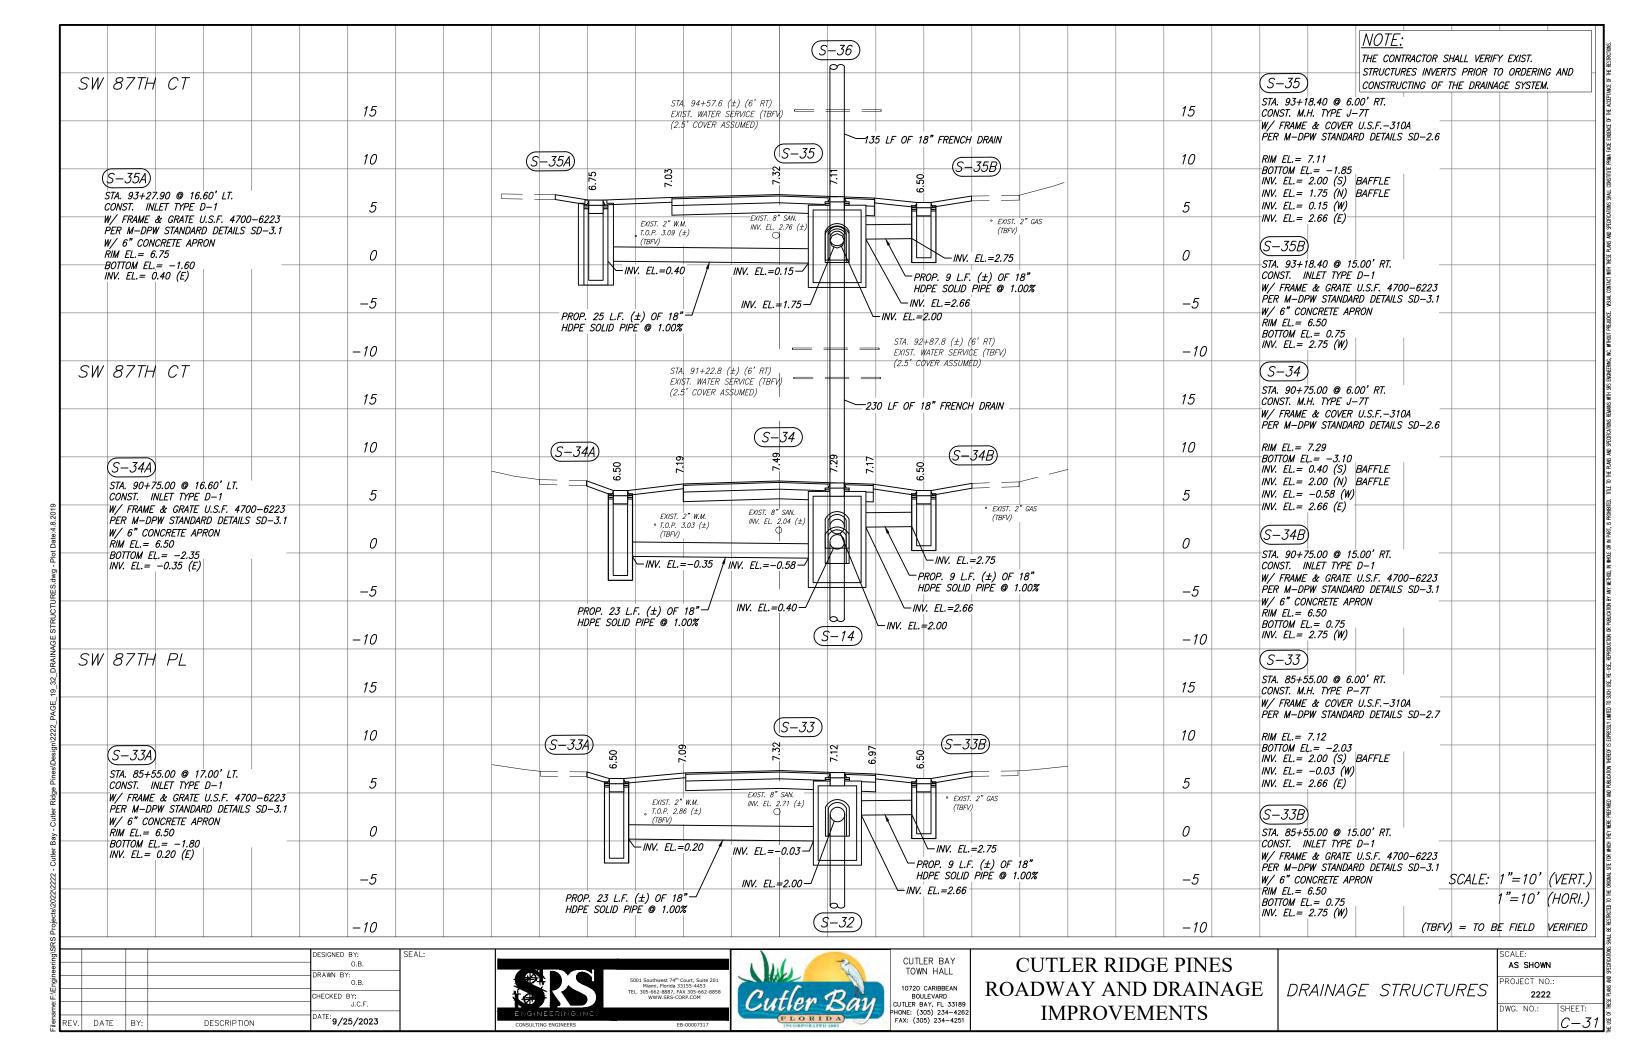

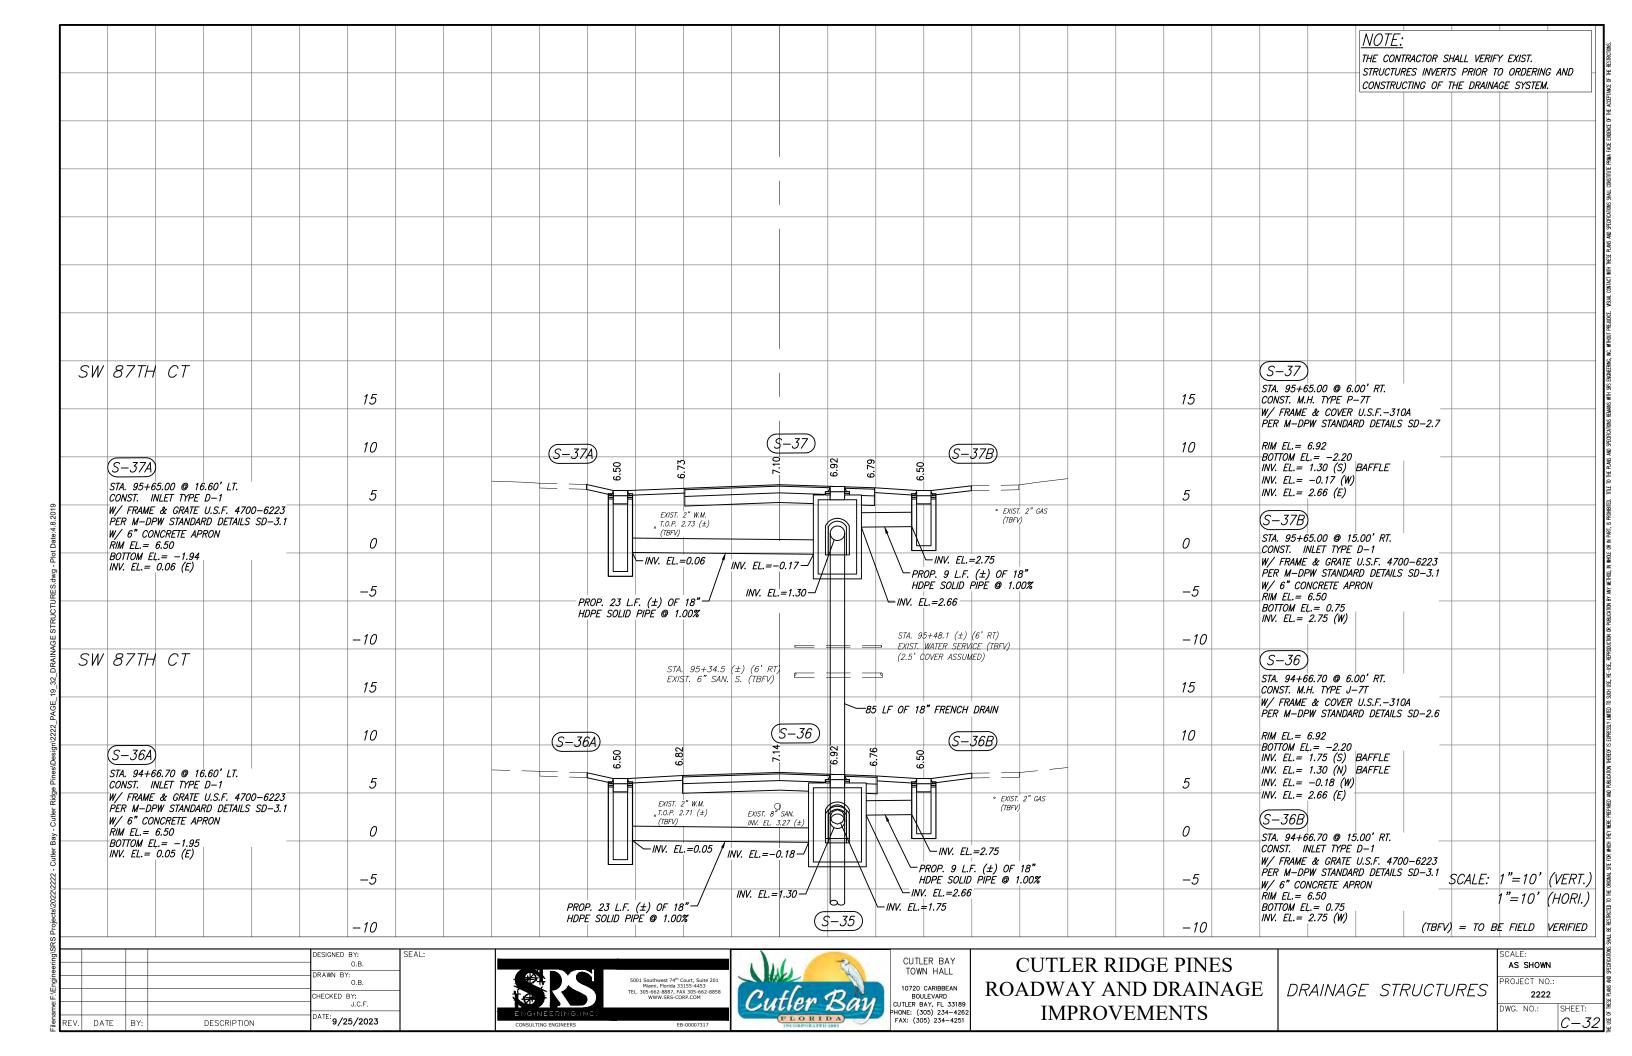

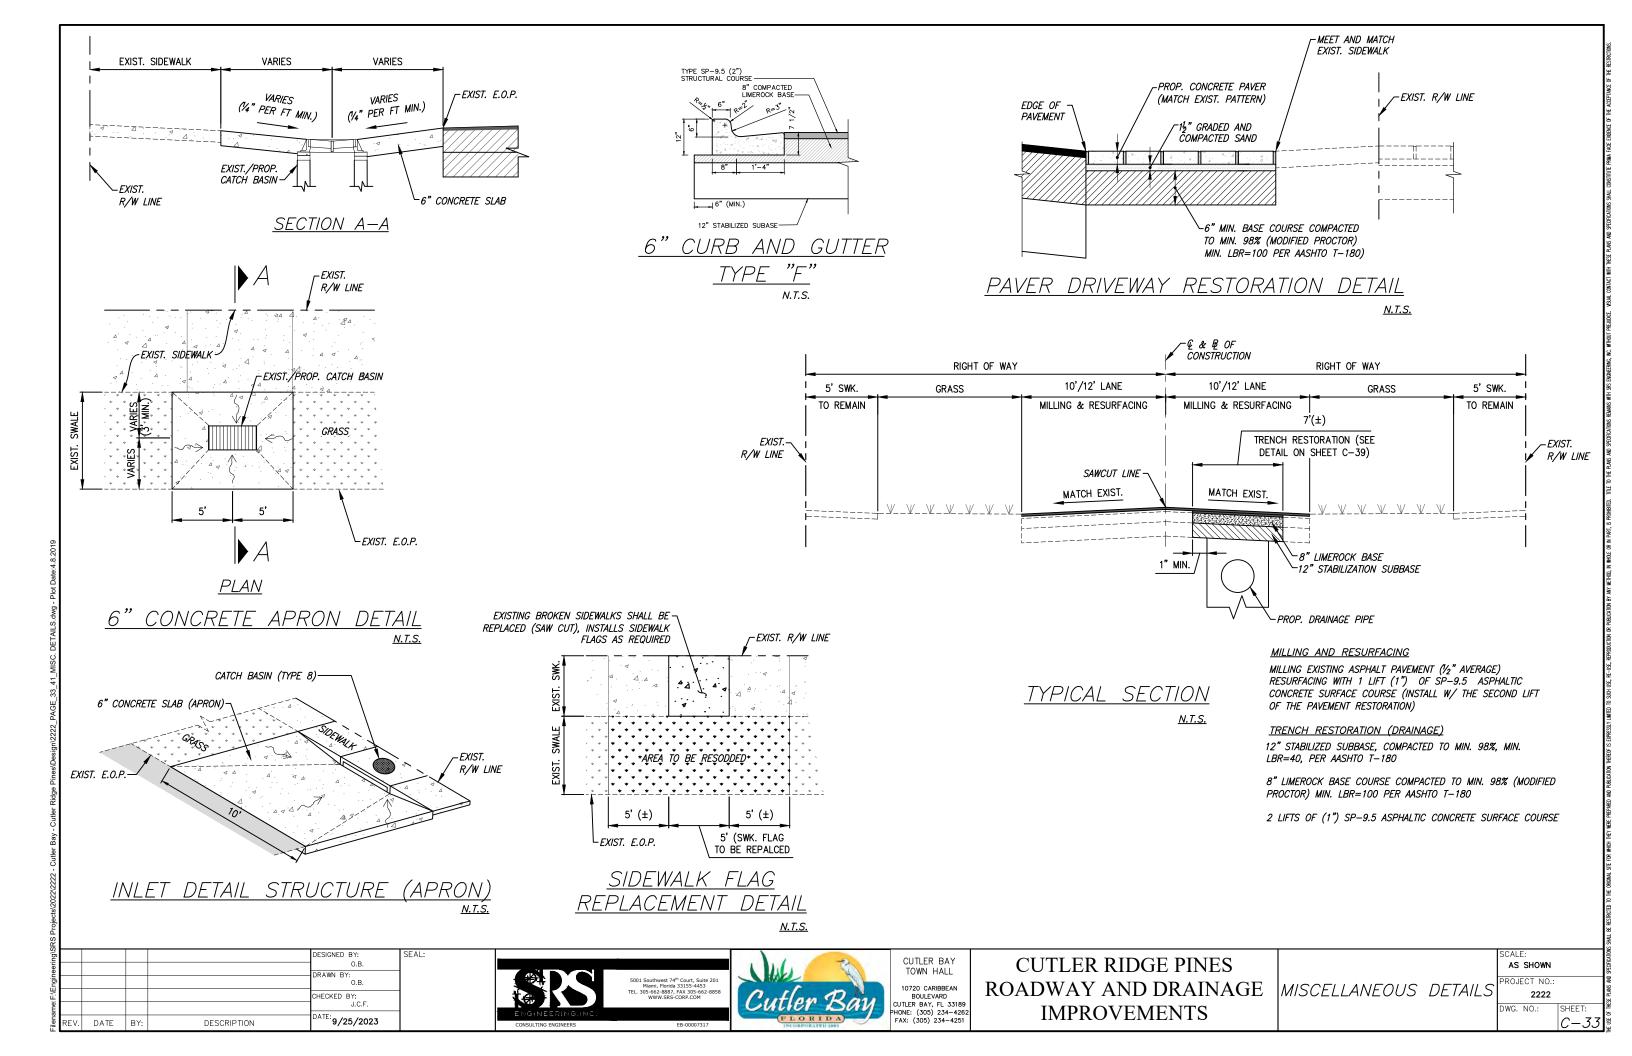

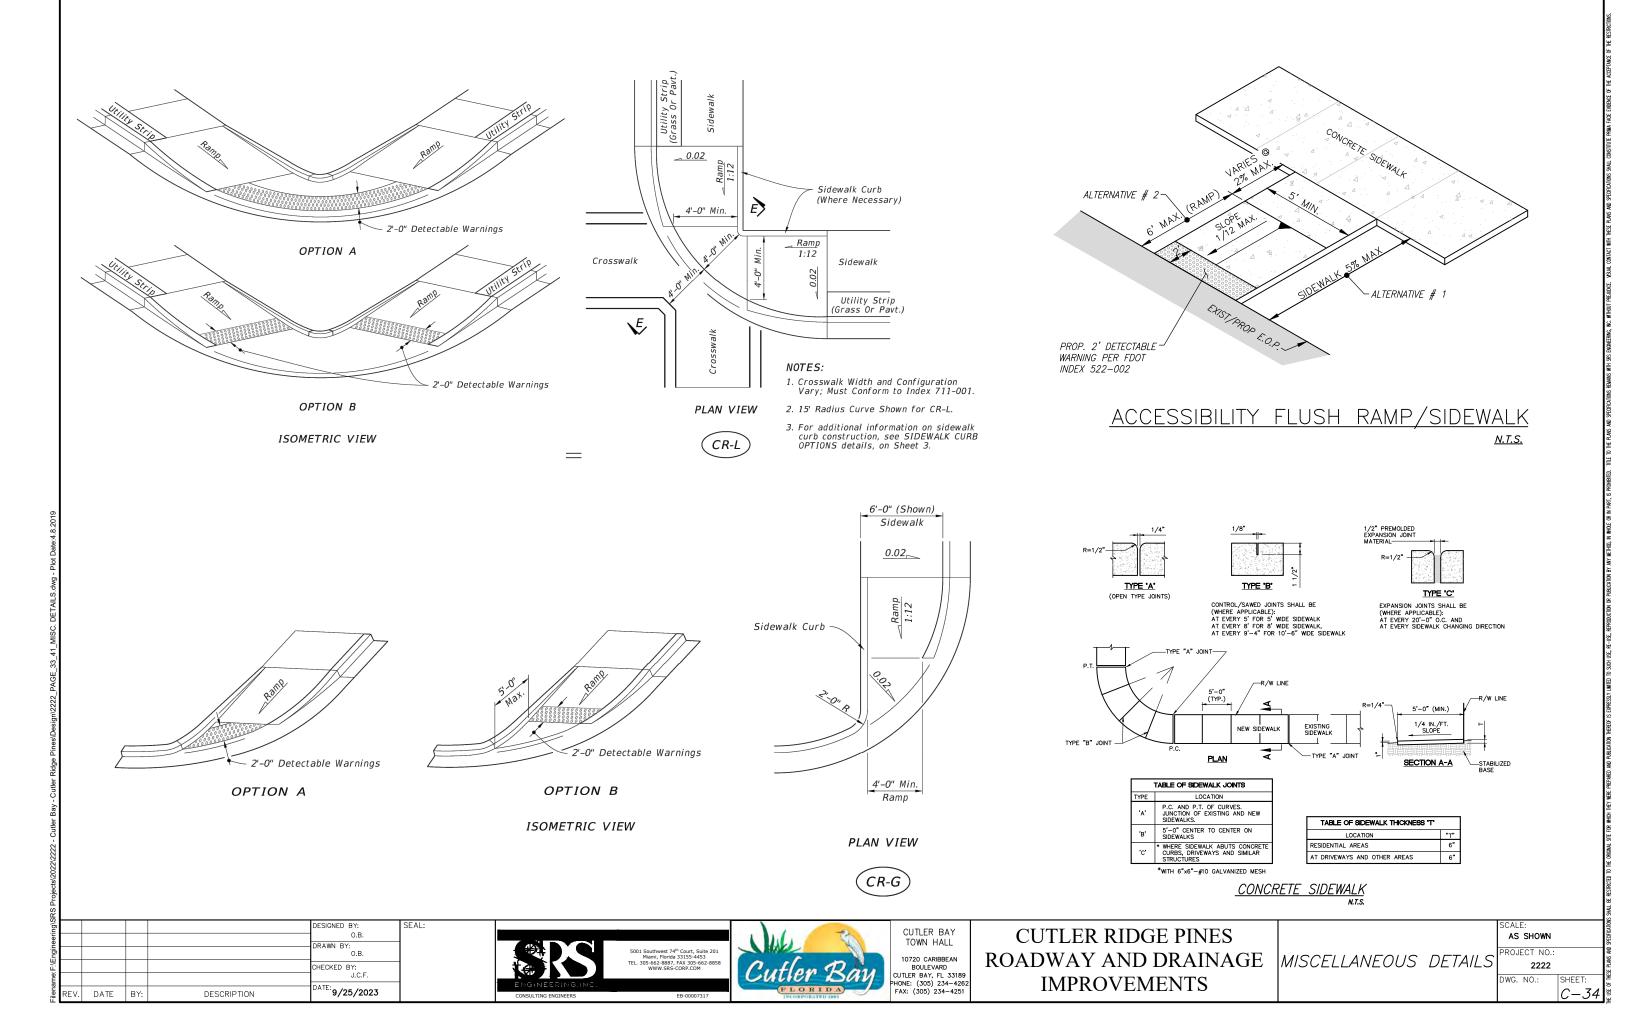

-PIPE BANDS ARE TO BE INSTALLED PER MANUFACTURER SPECIFICATIONS

FABRIC ON ALL SIDES, TOP AND

BOTTOM OF

TRENCH

GRATE EL. REFERS TO

- SELECT -

FILL

THIS POINT

ASPHAL₁

NOTES CONTINUED

- THE MINIMUM PIPE DIAMETER FOR DRAINAGE SYSTEM WITHIN THE ROADWAY RIGHT—OF—WAY SHALL BE 18 INCHES. 15 INCH PIPE MAY BE USED IN PRIVATE ROADWAYS.
 NO TREES TO BE PLANTED WITHIN 5 FEET OF THE EDGE OF THE TRENCH.
- TYPE "P" S.D. 2.6 STRUCTURE IS RECOMMENDED FOR SMALL DRAINAGE AREAS LESS THAN 0.2 ACRE PER CATCH BASIN. TYPE "J" S.D. 2.6 STRUCTURE IS RECOMMENDED FOR AREAS LARGER THAN 0.2 ACRE.
- ALL INVERTS OF PERFORATED PIPES TO BE AT MEAN HIGH OCTOBER WATER TABLE W.C. 2.2.
 PIPES CAN BE ALLOWED BELOW MEAN HIGH OCTOBER WATER TABLE DUE TO UTILITY CONFLICTS OR IN ORDER TO PROVIDE THE
- NEQUIRED MINIMUM COVER.

 9. NEOPRENE GASKET REQUIRED FOR BAFFLES ON ALL CONTACT EDGES MOUNTED ON WALL.

 10. OIL AND GREASE BAFFLE IS REQUIRED FOR ALL DRAINAGE STRUCTURES PRECEDING AN OUTFALL OR EXFILTRATION TRENCHES, IN PROJECTS LOCATED IN WELLFIELD PROTECTION AREAS, ROAD INTERSECTIONS WITH TRAFFIC LIGHTS, AND LARGE PARKING LOTS WHICH INCLUDE 15 PARKING SPACES OR MORE.

 11. OIL AND GREASE BAFFLE MAY BE WAIVED IN SUBURBAN RESIDENTIAL AREAS.

GENERAL NOTES FOR PIPE CULVERTS

CONTRACTOR HAS THE OPTION OF INSTALLING ANY PIPE MEETING THE REQUIREMENTS OF SECTION 443-2 OF THE FDOT STANDARD SPECIFICATIONS FOR ROAD AND BRIDGE CONSTRUCTION AS LONG AS THE MANUFACTURER IS LISTED, AT THE TIME OF PIPE INSTALLATION, IN FDOT'S LIST OF PRODUCERS WITH ACCEPTED QUALITY CONTROL PROGRAMS. PIPES WITH LESS THAN A 100-YEAR CERTIFICATION CANNOT BE USED ON SECTION LINE, HALF SECTION LINE, COLLECTOR ROADWAYS, AND ARTERIALS. 50-YEAR PIPE CERTIFICATION REQUIRED FOR ALL OTHER MINOR/LOCAL ROADWAYS.

MINIMUM NUMBER	OF PERFORATION	N PIPE CULVERTS
PIPE DIAMETER	OUTER SHELL	LINER
(inches)	No. of ¾" Dia. Holes (PER LIN. FT. OF PIPE)	No. of %" Dia. Holes (PER LIN. FT. OF PIPE)
15	100	50
18	120	60
24	160	80
30	200	100
36	240	120
42	275	140
48	315	150
54	355	180
60	395	200
72	470	235
84	550	275

NOTE:

PERFORATIONS SHALL BE UNIFORMLY SPACED AROUND THE FULL PERIPHERY OF THE PIPE TO WITHIN 4" OF EACH END OF EACH LENGTH OF PIPE. THE NUMBER OF PERFORATIONS PER LINEAR FOOT OF PIPE AND THE DIAMETER OF THE PERFORATIONS SHALL BE AS SHOWN ON THE ABOVE TABLE.

MIAMI-DADE COUNTY	ADDDOVED	REVISED	STANDARD STORM DRAINAGE DETAIL	SD
DEPARTMENT OF TRANSPORTATION AND PUBLIC WORKS	APPROVED 04/16/2015	06-04-86 10-22-13 05-02-81	EXFILTRATION TRENCH (PIPE CULVERT NOTES)	1.1 SHEET_2_OF_2

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me					J.C.F.	
ilename:	REV.	DATE	BY:	DESCRIPTION	DATE: 9/25/2023	

04/16/2015

09/26/2012

10/19/2012

DEPARTMENT OF

TRANSPORTATION

AND PUBLIC WORKS



1.1

SHEET 1 OF 2

EXFILTRATION TRENCH

(FRENCH DRAIN)




TOWN HALL 10720 CARIBBEAN BOULEVARD CUTLER BAY, FL 33189

CUTLER RIDGE PINES ROADWAY AND DRAINAGE **IMPROVEMENTS**

MISCELLANEOUS DETAILS

AS SHOWN PROJECT NO 2222

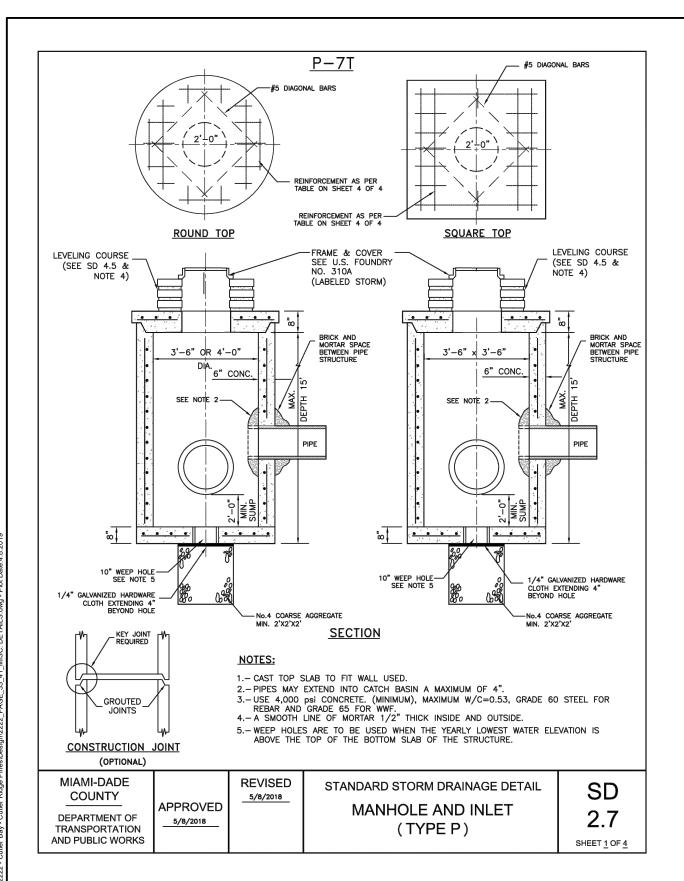

			P	OLLUTION	ONTR	OL STRUC	CTURE			
Standard Detail	Width (ft)	Length (ft)	Height (ft)	Wall Thickness (in)	Wall Steel	Top Slab Thickness (in)	Top Slab Steel	Bottom Slab Thickness (in)	Bottom Slab Steel	Bottom Slab Overhang (in)
5.2-3C	8.0	14.0	0.0 - 5.0	10.0	#5@9.5"H #4@10"V	10.0	#6@6" E.W.	10.0	#4@8" E.W.	12.0
5.2-3C	8.0	14.0	5.1 - 10.0	10.0	#7@9"H #4@10"V	10.0	#6@6" E.W.	10.0	#4@8" E.W.	12.0
5.2-3C	8.0	14.0	10.1 - 15.0	10.0	#8@8"H #4@10"V	10.0	#6@6" E.W.	10.0	#4@8" E.W.	12.0
5.2-2C	8.0	9.0	0.0 - 5.0	8.0	#5@9.5"H #4@10"V	10.0	#6@6" E.W.	10.0	#4@8" E.W.	12.0
5.2-2C	8.0	9.0	5.1 - 10.0	8.0	#7@9"H #4@10"V	10.0	#6@6" E.W.	10.0	#4@8" E.W.	12.0
5.2-2C	8.0	9.0	10.1-15.0	8.0	#8@8"H #4@10"V	10.0	#6@6" E.W.	10.0	<u>#4@8"</u> E.W.	12.0

5.2-3C - POLLUTION CONTROL STRUCTURE 3 CHAMBER 5.2-2C - POLLUTION CONTROL STRUCTURE 2 CHAMBER

MIAMI-DADE
COUNTY
DEPARTMENT (

TRANSPORTATION AND PUBLIC WORKS **REVISED** 5/8/2018

APPROVED

5/8/2018

STANDARD STORM DRAINAGE DETAIL POLLUTION CONTROL **STRUCTURE**

SD 5.2

SHEET 4 OF 4

				DESIGNED BY:	SEAL:
				O.B.	
				DRAWN BY:	1
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				CHECKED BY:	1
				J.C.F.	
RFV	DATE	BY:	DESCRIPTION	DATE: 9/25/2023	






CUTLER RIDGE PINES TOWN HALL ROADWAY AND DRAINAGE 10720 CARIBBEAN BOULEVARD CUTLER BAY, FL 33189 PHONE: (305) 234-4262 **IMPROVEMENTS**

MISCELLANEOUS DETAILS

	SCALE: AS SHOWN	
_	PROJECT NO.:	
ا ر	2222	
	DWG. NO.:	SHEET:

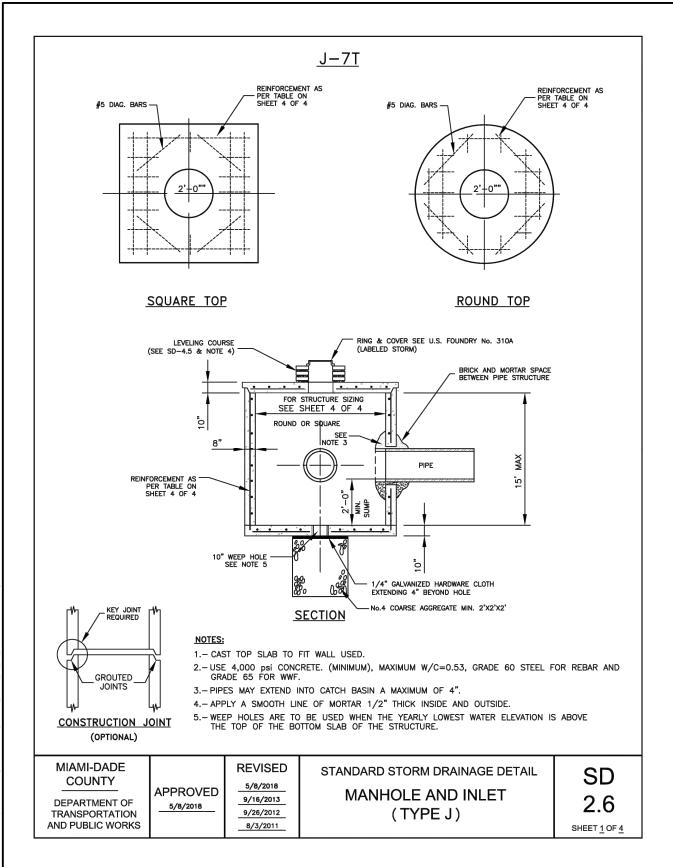

SQUARE STRUCTURE

Standard Detail	Width (ft) Min.	Length (ft) Max.	Height (ft)	Wall Thickness (in)	Wall Steel	Top Slab Thickness (in)	Top Slab Steel	Bottom Slab Thickness (in)	Bottom Slab Steel
2.6	8	8	0.0 - 5.0	8	#4@7"H #4@10"V	10	#6@6" E.W.	10	#5@8.5" E.W.
2.6	8	8	5.1 - 10.0	8	#6@7.5"H #4@10"V	10	#6@6" E.W.	10	#5@8.5" E.W.
2.6	8	8	10.1-15.0	8	<u>#7@7"H</u> #4@10"V	10	#6@6" E.W.	10	#5@8.5" E.W.

ROUND STRUCTURE

Standard Detail	Dia. (ft) Min.	Dia. (ft) Max.	Height (ft)	Wall Thickness (in)	Wall Steel	Top Slab Thickness (in)	Top Slab Steel	Bottom Slab Thickness (in)	Bottom Slab Steel
2.6	5	7	0.0 - 5.0	8	8 x 8 W20 or #4@10"E.W	10	#6@6" E.W.	10	<u>#5@8.5"</u> E.W.
2.6	5	7	5.1 - 10.0	8	8 x 8 W20 or #4@10"E.W	10	#6@6" E.W.	10	<u>#5@8.5"</u> E.W.
2.6	5	7	10.1 - 15.0	8	8 x 8 W20 or #4@10"E.W	10	#6@6" E.W.	10	<u>#5@8.5"</u> E.W.

MIAMI-DADE REVISED COUNTY 5/8/2018 APPROVED DEPARTMENT OF 1/26/2012 TRANSPORTATION 8/3/2011 AND PUBLIC WORKS

STANDARD STORM DRAINAGE DETAIL MANHOLE AND INLET (TYPE J)

SD 2.6 SHEET 4 OF 4

ESIGNED BY: CHECKED BY: J.C.F. OATE: 9/25/2023 DESCRIPTION REV. DATE BY:






CUTLER RIDGE PINES ROADWAY AND DRAINAGE **IMPROVEMENTS**

MISCELLANEOUS DETAILS

AS SHOWN 2222 DWG. NO.:

TOWN HALL 10720 CARIBBEAN BOULEVARD CUTLER BAY, FL 33189 PHONE: (305) 234-4262 FAX: (305) 234-4251

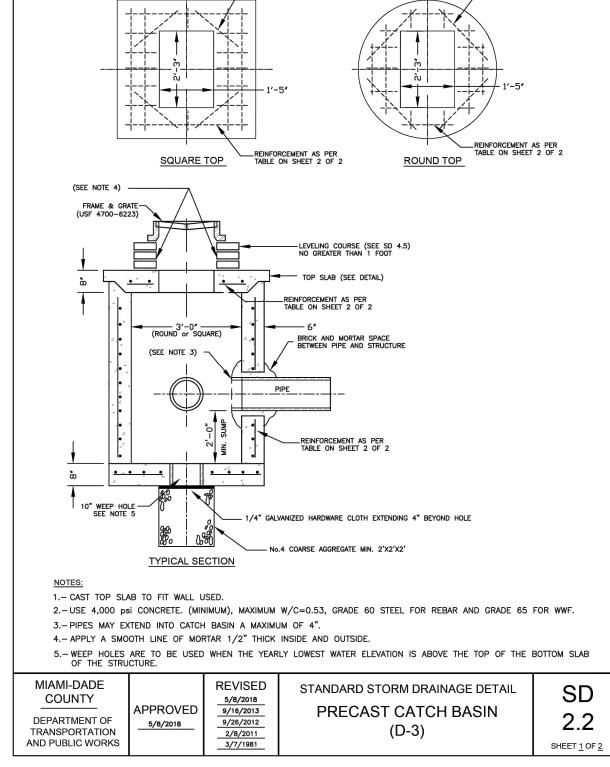

	POLLUTION CONTROL STRUCTURE												
Standard Detail	Width (ft)	Length (ft)	Height (ft)	Wall Thickness (in)	Wall Steel	Top Slab Thickness (in)	Top Slab Steel	Bottom Slab Thickness (in)	Bottom Slab Steel	Bottom Slab Overhang (in)			
5.2-3C	8.0	14.0	0.0 - 5.0	10.0	#5@9.5"H #4@10"V	10.0	#6@6" E.W.	10.0	#4@8" E.W.	12.0			
5.2-3C	8.0	14.0	5.1 - 10.0	10.0	#7@9"H #4@10"V	10.0	#6@6" E.W.	10.0	#4@8" E.W.	12.0			
5.2-3C	8.0	14.0	10.1 - 15.0	10.0	#8@8"H #4@10"V	10.0	#6@6" E.W.	10.0	#4@8" E.W.	12.0			
5.2-2C	8.0	9.0	0.0 - 5.0	8.0	#5@9.5"H #4@10"V	10.0	#6@6" E.W.	10.0	#4@8" E.W.	12.0			
5.2-2C	8.0	9.0	5.1 - 10.0	8.0	#7@9"H #4@10"V	10.0	#6@6" E.W.	10.0	#4@8" E.W.	12.0			
5.2-2C	8.0	9.0	10.1-15.0	8.0	#8@8"H #4@10"V	10.0	#6@6" E.W.	10.0	#4@8" E.W.	12.0			

5.2-3C - POLLUTION CONTROL STRUCTURE 3 CHAMBER 5.2-2C - POLLUTION CONTROL STRUCTURE 2 CHAMBER

MIAMI-DADE COUNTY
DEPARTMENT OF TRANSPORTATION

AND PUBLIC WORKS

APPROVED 5/8/2018

REVISED 5/8/2018

STANDARD STORM DRAINAGE DETAIL POLLUTION CONTROL STRUCTURE

SD 5.2

SHEET 4 OF 4

				DESIGNED BY:	SEAL:
				O.B.	
				DRAWN BY:	
				O.B.	
				CHECKED BY:	
				J.C.F.	
DEV/	DATE	DV.	DESCRIPTION	DATE: 9 /25 /2023	



#5 DIAGONAL BARS




TOWN HALL 10720 CARIBBEAN BOULEVARD CUTLER BAY, FL 33189 PHONE: (305) 234-4262 FAX: (305) 234-4251


CUTLER RIDGE PINES ROADWAY AND DRAINAGE MISCELLANEOUS DETAILS **IMPROVEMENTS**

SCALE:
AS SHOWN
PROJECT NO.:
2222

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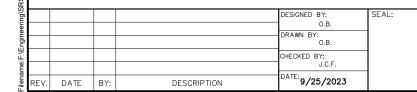
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PAVEMENT RESTORATION FOR TRENCHES CUT IN PUBLIC R/W (R-21.1 M-DPW STANDARD DETAILS)

BAFFLE DETAIL (FDOT INDEX 443-002)

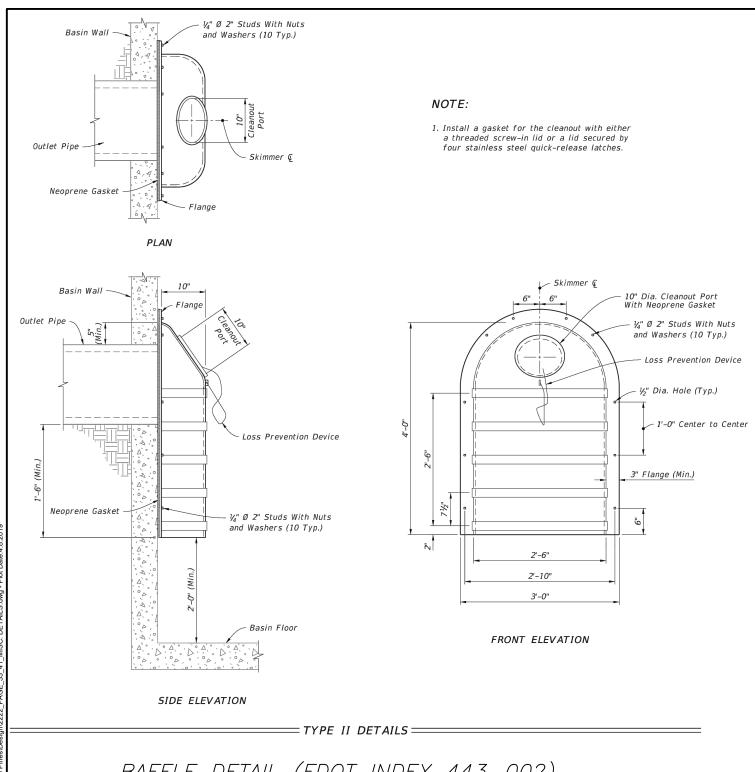

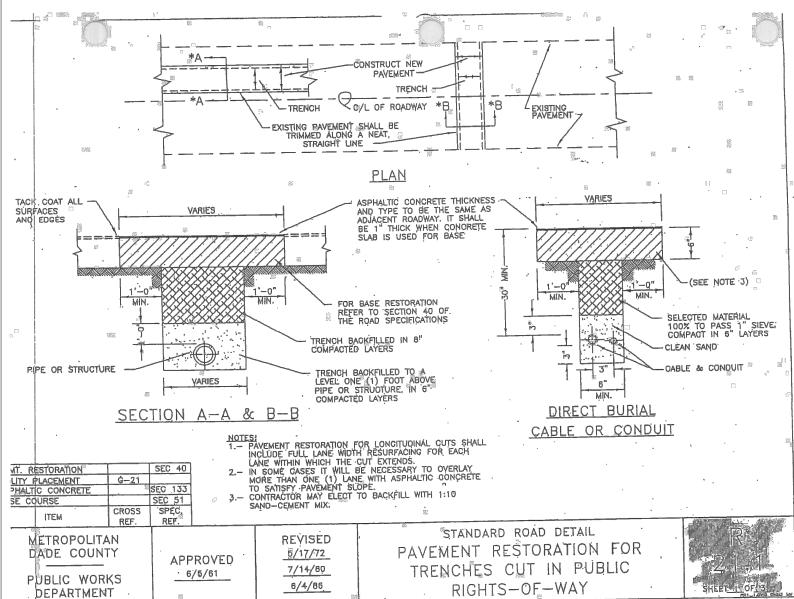




CUTLER BAY TOWN HALL 10720 CARIBBEAN BOULEVARD CUTLER BAY, FL 33189

CUTLER RIDGE PINES ROADWAY AND DRAINAGE **IMPROVEMENTS**


MISCELLANEOUS DETAILS

	SCALE:	
	AS SHOWN	
_	PROJECT NO.:	
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	DWG. NO.:	SHEET

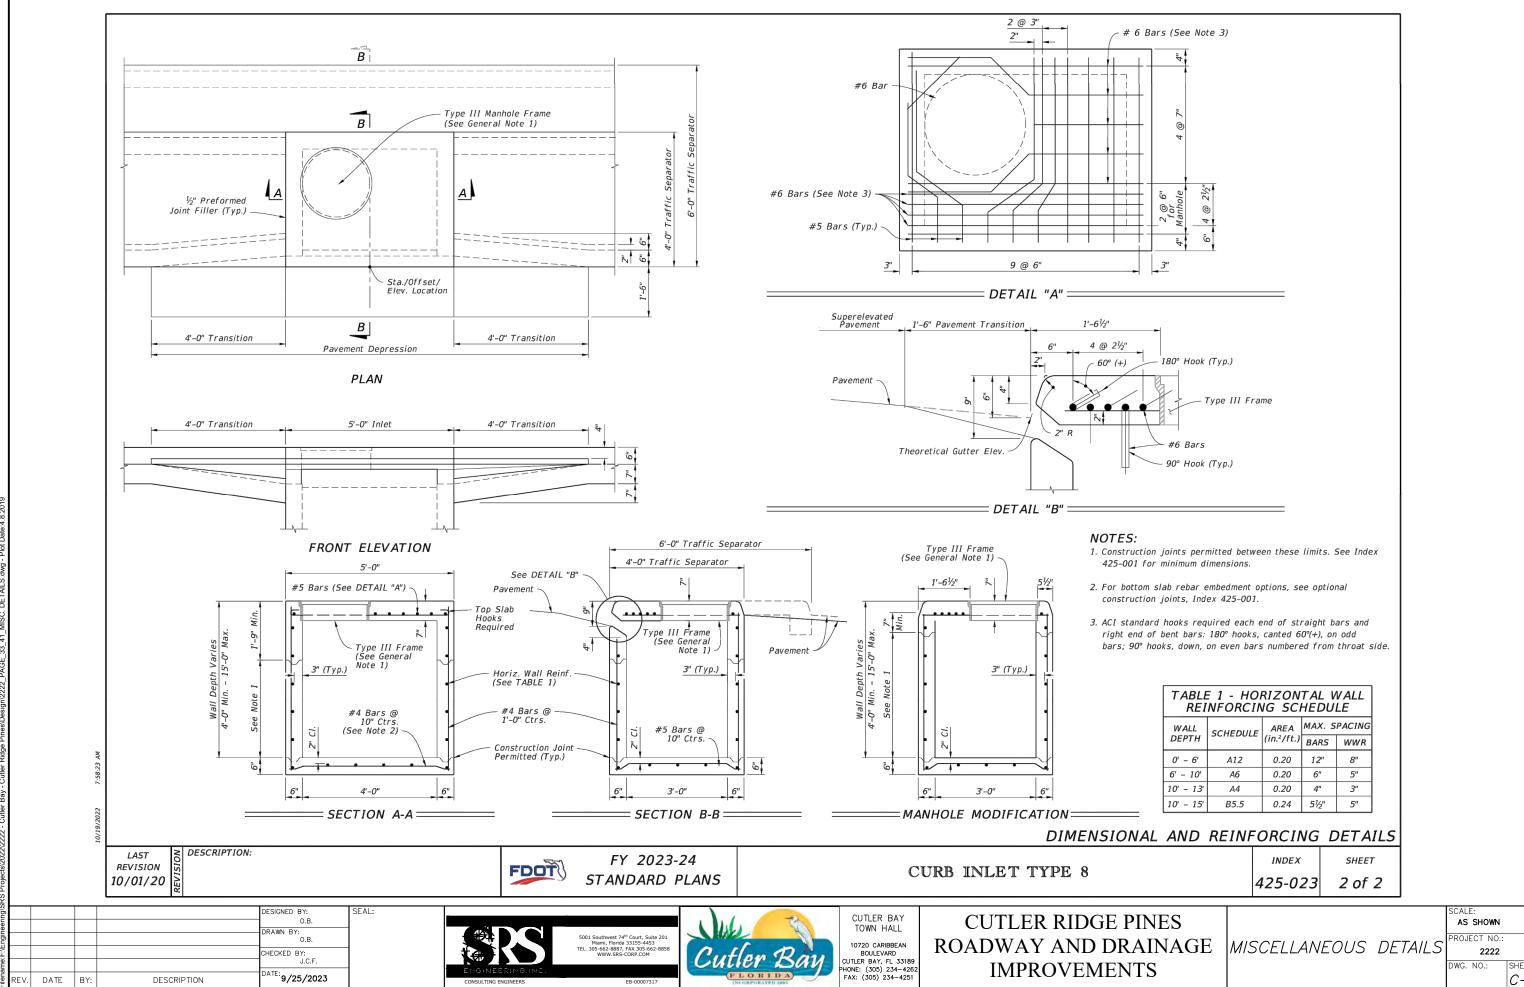

DATE BY:

DESCRIPTION

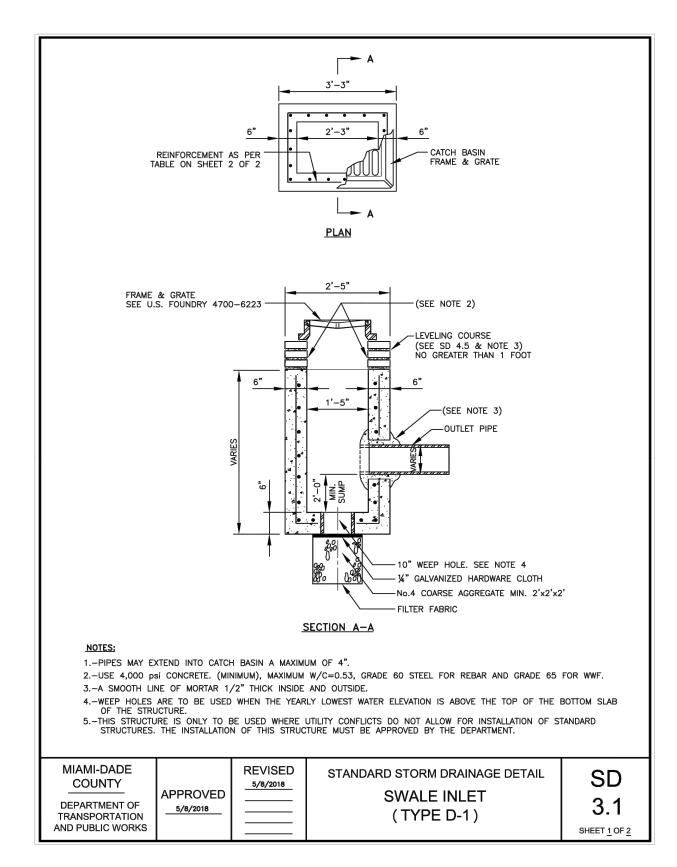

	RECTANGULAR BOX											
Standard Detail	Width (ft)	Length (ft)	Height (ft)	Wall Thickness (in)	Wall Steel	Top Slab Thickness (in)	Top Slab Steel	Bottom Slab Thickness (in)	Bottom Slab Steel	Bottom Slab Overhang		
3.1	1.42	2.25	0 - 5.0	6"	#4@10"H #4@10"V	I N/A	N/A	6"	#4@12" E.W.	6"		
3.1	1.42	2.25	5.1 - 10.0	6"	#4@10"H #4@10"V	I N/A	N/A	6"	#4@12" E.W.	N/A		
3.1	1.42	2.25	10.1-15.0	6"	#4@6"H #4@10"V	N/A	N/A	8"	#4@12" E.W.	N/A		

MIAMI-DADE COUNTY		REVISED 5/8/2018	STANDARD STORM DRAINAGE DETAIL	SD
	APPROVED5/8/2018		SWALE INLET (TYPE D-1)	3.1
AND PUBLIC WORKS			, ,	SHEET <u>2</u> OF <u>2</u>

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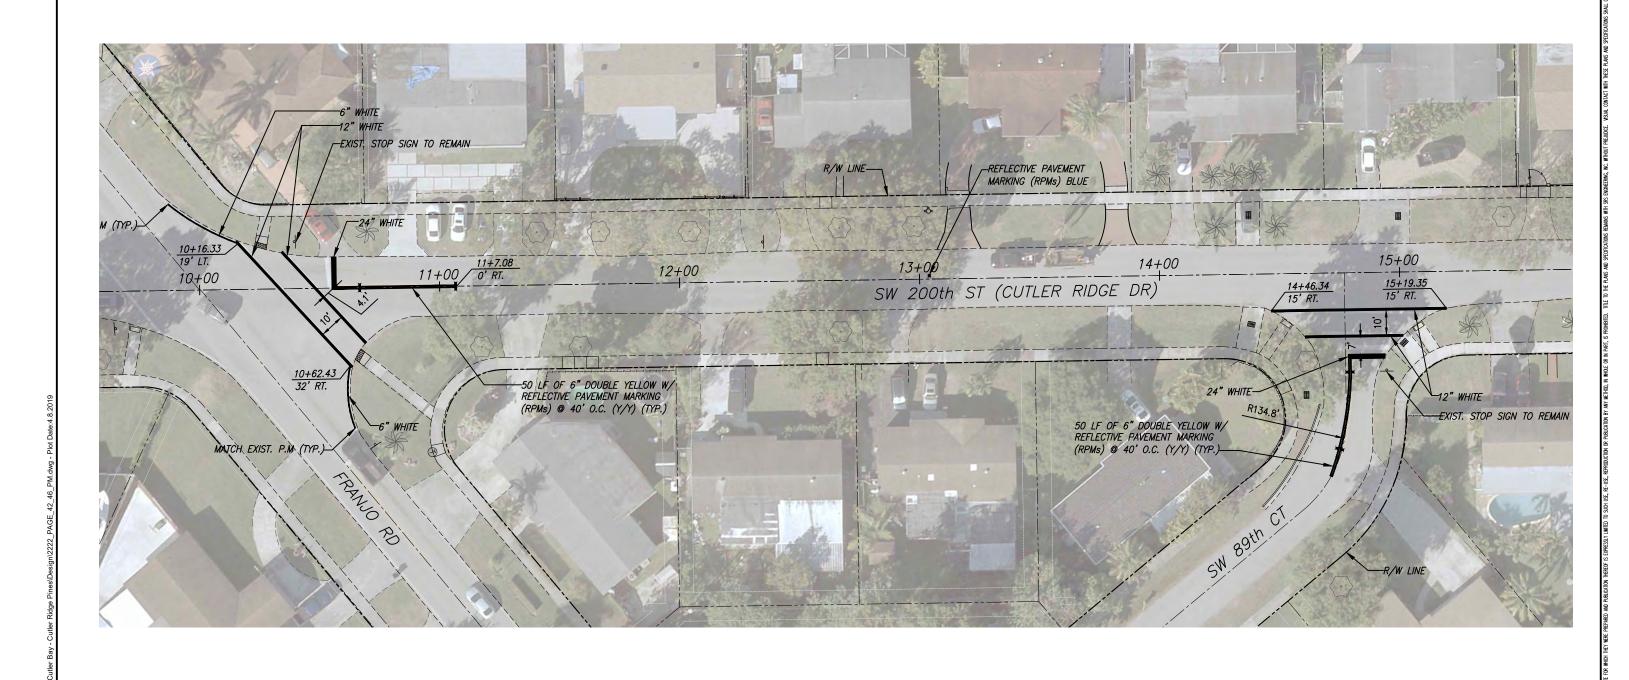



TOWN HALL 10720 CARIBBEAN BOULEVARD CUTLER BAY, FL 33189 PHONE: (305) 234-4262 FAX: (305) 234-4251

CUTLER RIDGE PINES ROADWAY AND DRAINAGE MISCELLANEOUS DETAILS **IMPROVEMENTS**

AS SHOWN PROJECT NO. 2222





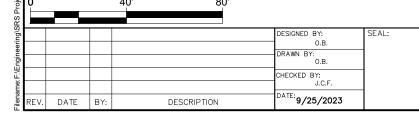





CUTLER BAY TOWN HALL


10720 CARIBBEAN BOULEVARD
CUTLER BAY, FL 33189
PHONE: (305) 234–4262
FAX: (305) 234–4251


CUTLER RIDGE PINES ROADWAY AND DRAINAGE IMPROVEMENTS


PAVEMENT MARKING AND SIGNAGE PLANS


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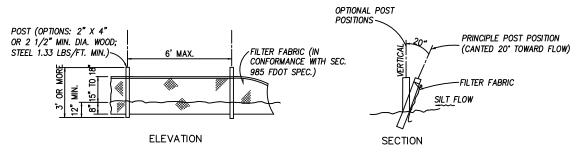




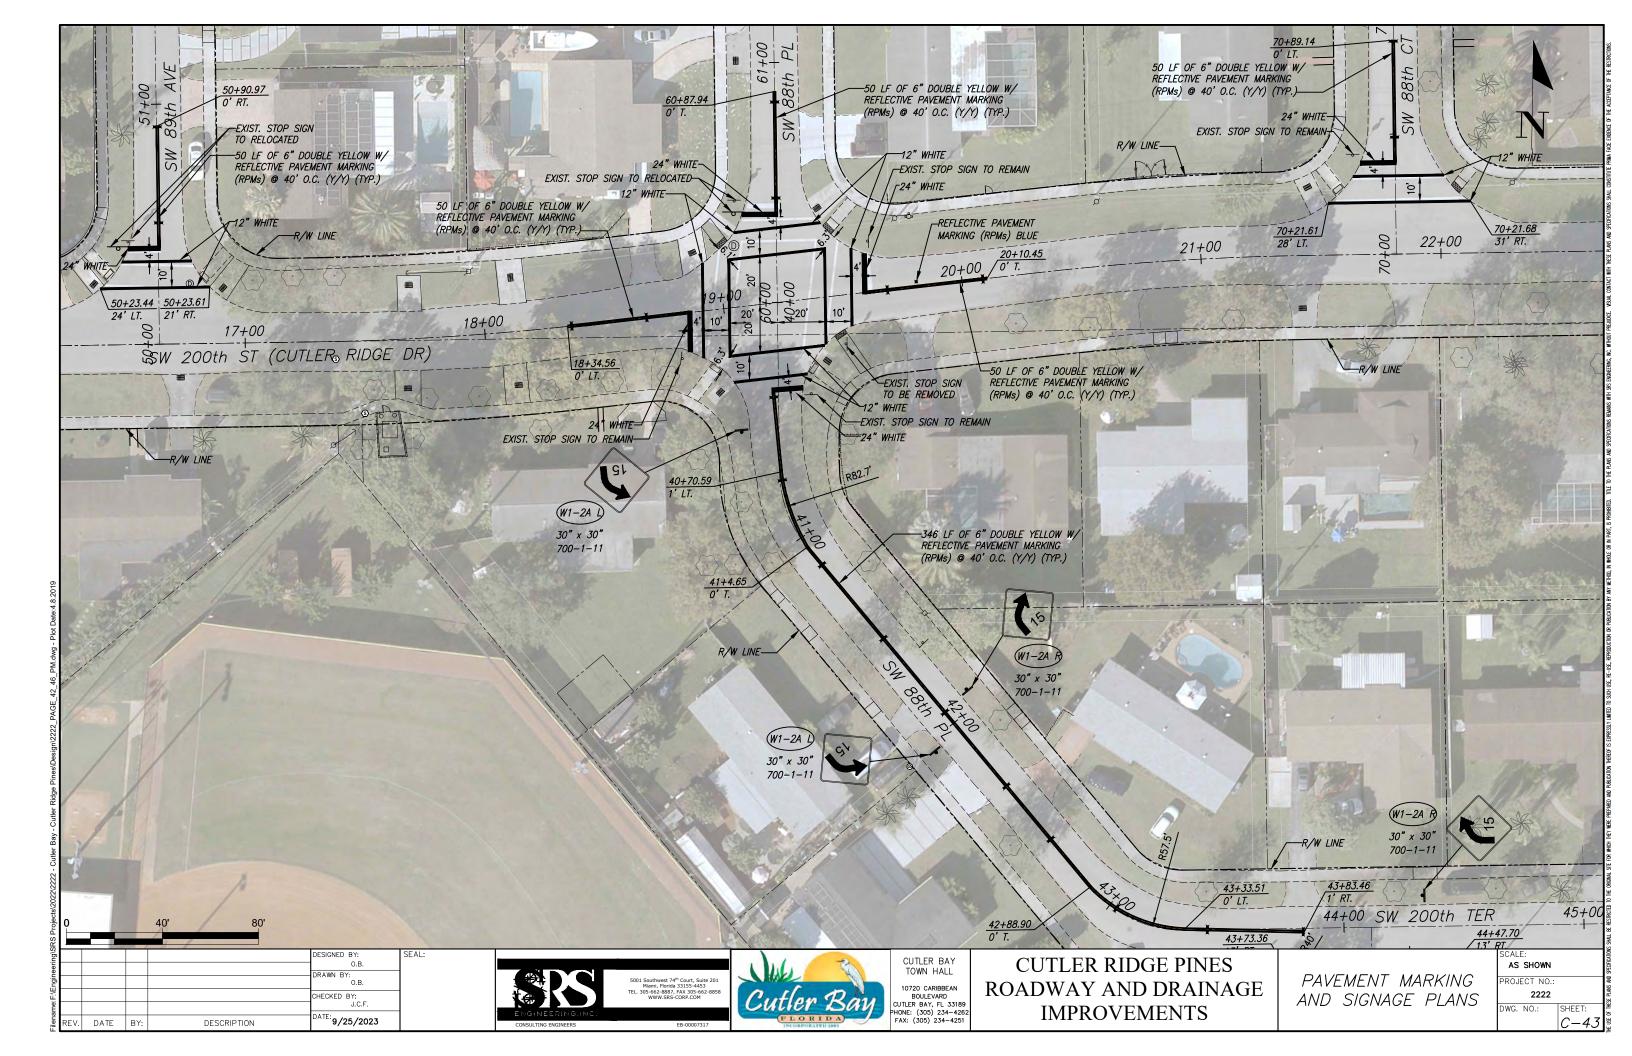


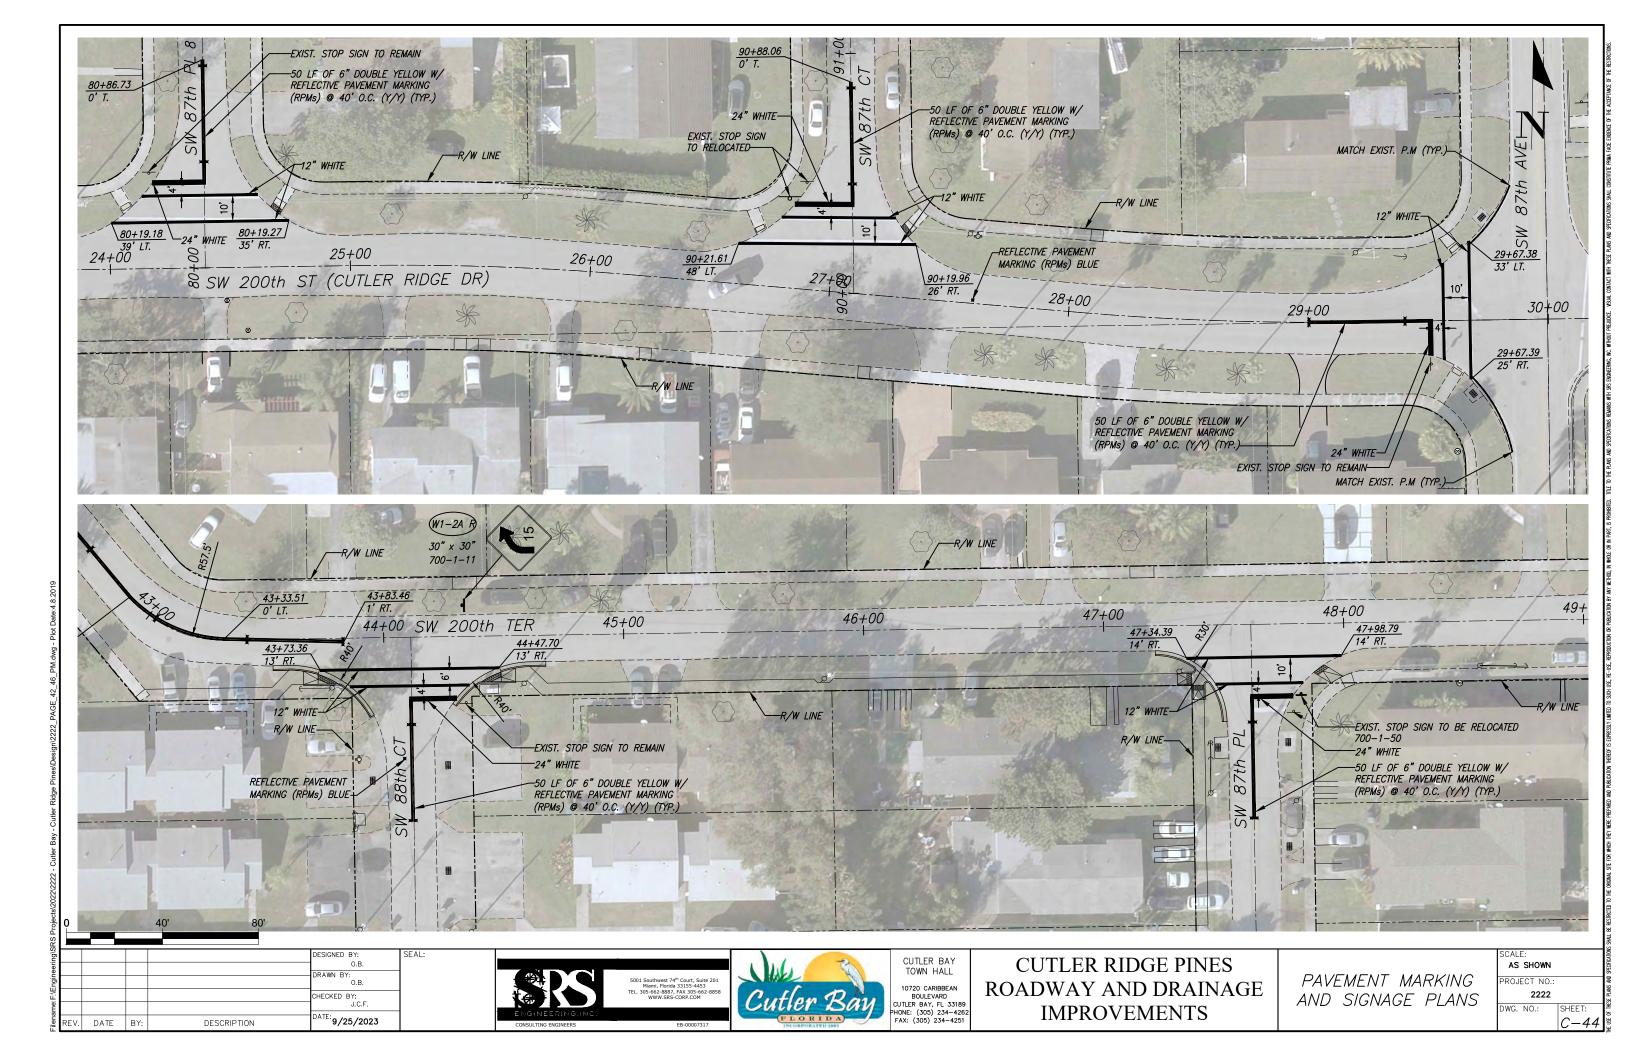NOTES FOR SYNTHETIC BALES OR BALE TYPE BARRIERS

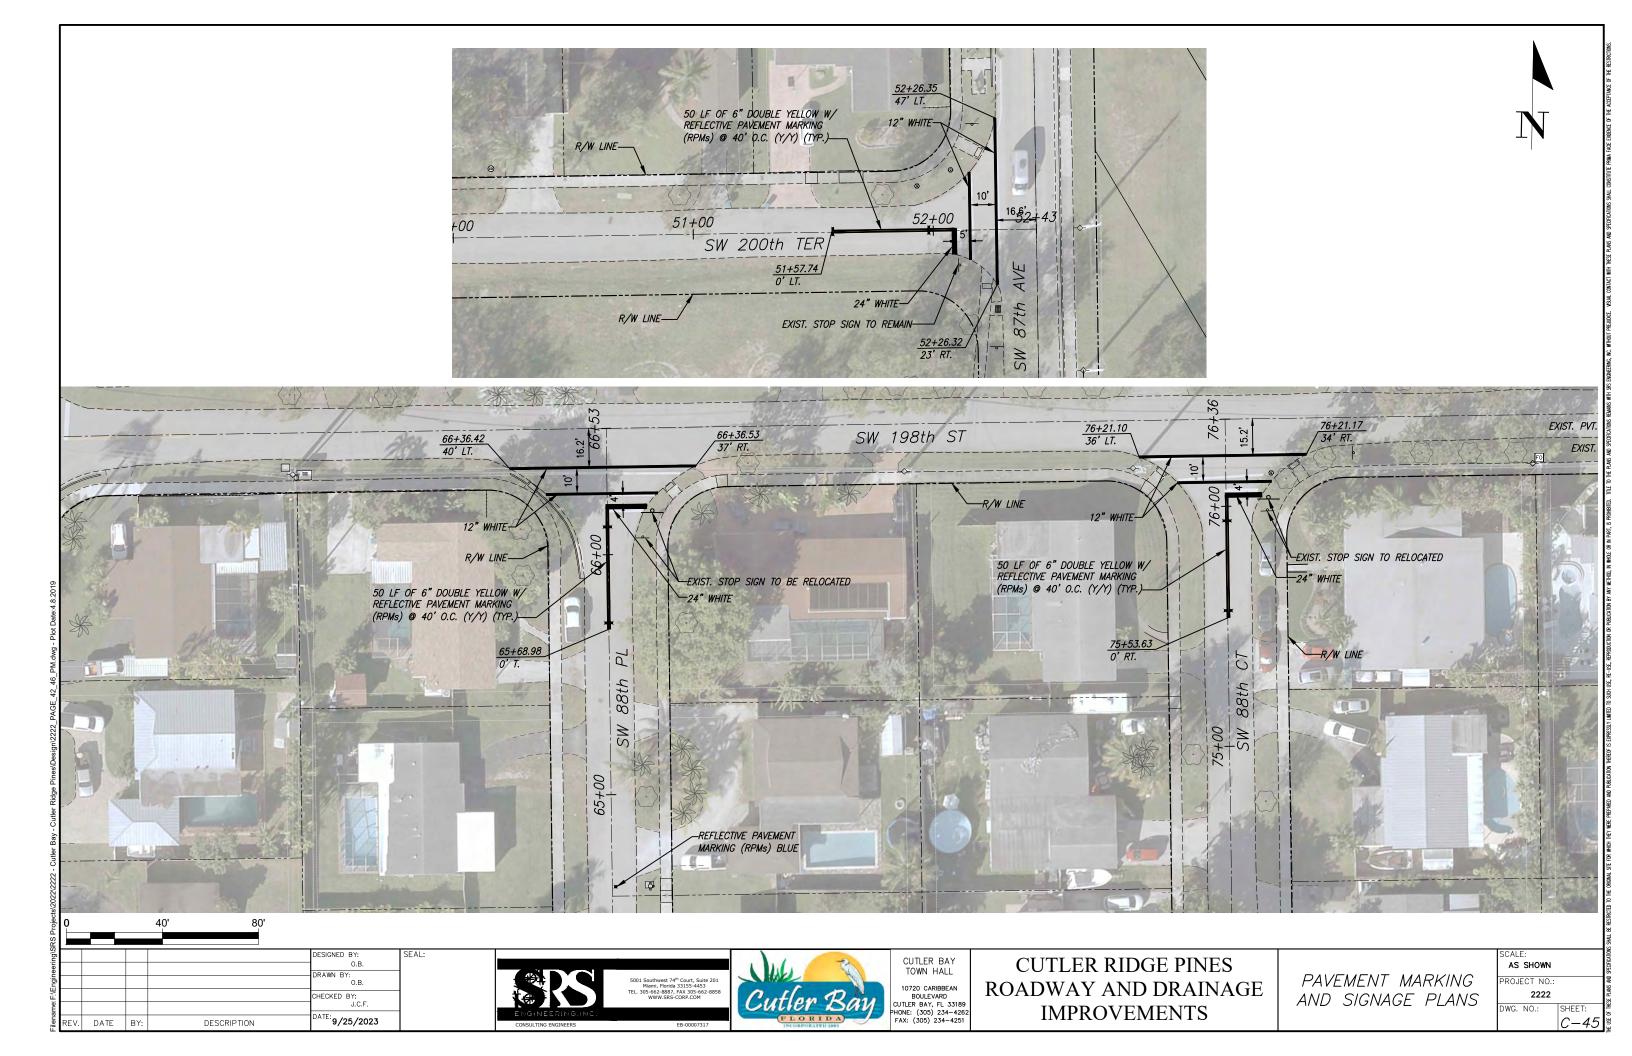- 1. TYPE I AND II SYNTHETIC BARRIER SHOULD BE SPACED IN ACCORDANCE WITH CHART 1, SHEET 1 PER INDEX 102.
- 2. BALES SHALL BE ANCHORED WITH 2-1" X 2" (OR 1" DIA.) X 4' WOOD STAKES. STAKES OF OTHER MATERIAL OR SHAPE PROVIDING EQUIVALENT STRENGTH MAY BE USED IF APPROVED BY THE ENGINEER. STAKES OTHER THAN WOOD SHALL BE REMOVED UPON COMPLETION OF THE PROJECT.
- 3. RAILS AND POSTS SHALL BE 2" X 4" WOOD. OTHER MATERIALS PROVIDING EQUIVALENT STRENGTH MAY BE USED IF APPROVED BY THE ENGINEER.
- 4. ADJACENT BALES SHALL BE BUTTED FIRMLY TOGETHER.
- 5. WHERE USED IN CONJUNCTION WITH SILT FENCE, BALES SHALL BE PLACED ON THE UPSTREAM SIDE OF THE FENCE.

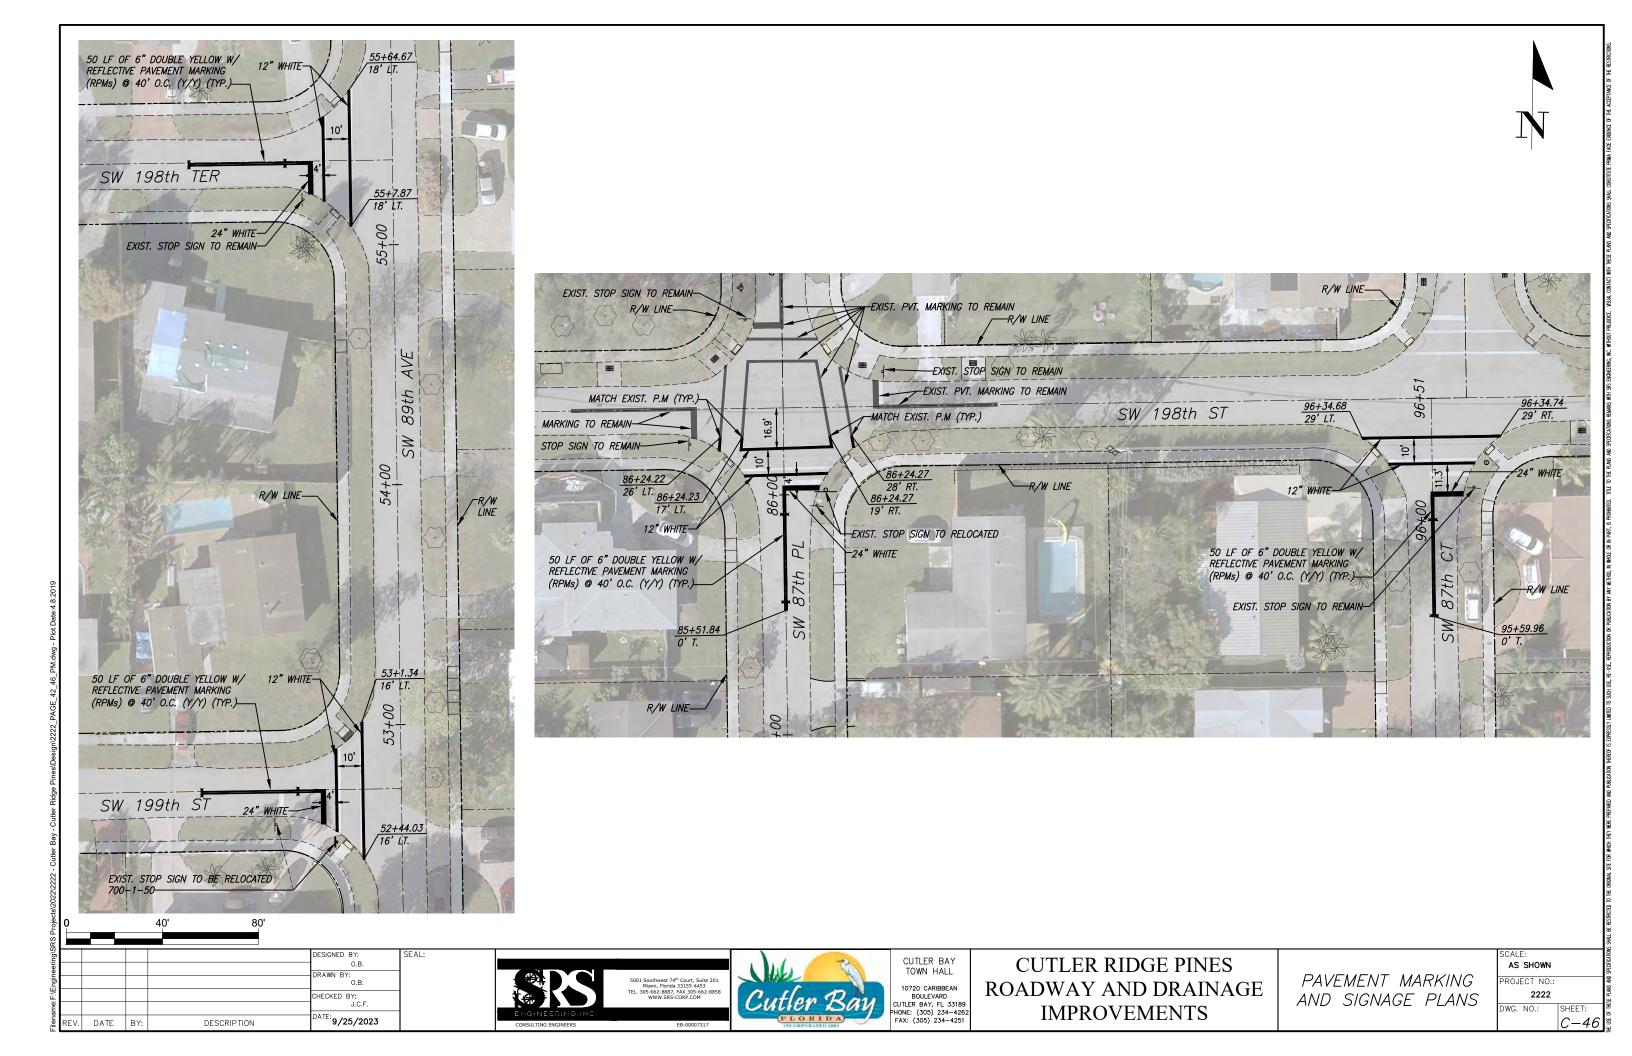


SILT FENCE DETAIL N.T.S.

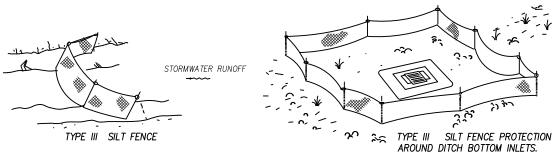

NOTES:


- SPACING FOR TYPE III FENCE TO BE IN ACCORDANCE WITH CHART I, SHEET 1 OF 3 AND DITCH INSTALLATIONS AT DRAINAGE STRUCTURES SHEET 2 OF 3 PER FDOT STANDARD INDEX 102.
- 2. DO NOT DEPLOY IN A MANNER THAT SILT FENCES WILL ACT AS A DAM ACROSS PERMANENT FLOWING WATERCOURSES. SILT FENCES ARE TO BE USED AT UPLAND LOCATIONS AND TURBIDITY BARRIERS USED AT PERMANENT BODIES OF WATER.


SILT FENCE APPLICATIONS N.T.S.

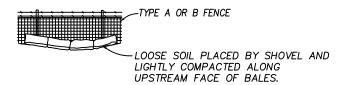

BALES BACKED BY FENCE



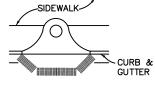

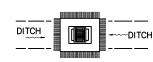

PARTIAL INLET

COMPLETED INLET

DITCH BOTTOM INLET

PROTECTION AROUND INLETS OR SIMILAR STRUCTURES

STORM WATER POLLUTION PREVENTION PRACTICES:

- 1. TREE PROTECTION AND PRUNING SHALL BE ACCOMPLISHED AS DETAILED IN SPECIAL PROVISIONS, THE CONSTRUCTION PLANS, AND OR PER TREE ORDINANCE 12636.
- 2. THE STORM WATER POLLUTION PREVENTION PLAN, SWPPP, SUBMITTED TO PUBLIC WORKS, SHALL DESCRIBE IN DETAIL HOW THE CONSTRUCTION EFFORT WILL BE PHASED WITH REGARDS TO MINIMIZING EROSION PROBLEMS BY THE USE OF TEMPORARY AND PERMANENT EROSION CONTROL MEASURES, FOR THE VARIOUS SEQUENCES OF CONSTRUCTION OPERATIONS. ANY MODIFICATIONS MUST BE APPROVED BY THE TOWN OF CUTLER BAY - NPDES SECTION, DEPARTMENT OF PUBLIC
- 3. ENVIRONMENTAL CONTROL FEATURES AS PROVIDED IN THE SWPPP, ARE TO BE INSTALLED AT ALL AREAS OF EXCAVATION OR FILL FOR DRAINAGE SYSTEM, OR STRUCTURE CONSTRUCTION PRIOR TO SUCH EXCAVATION OR FILL. INLET ENTRANCES ARE ALSO TO BE PROTECTED FROM SILTATION
- 4. ALL ENVIRONMENTAL CONTROL FEATURES ARE TO BE MAINTAINED THROUGHOUT THE LIFE OF THE PROJECT IN ACCORDANCE WITH N.P.D.E.S. REQUIREMENTS. THE CONTRACTOR MUST INSURE THAT ALL EROSION CONTROL FEATURES FUNCTION PROPERLY AT ALL TIMES.
- 5. ALL EROSION AND MATERIAL DEPOSITS MUST BE CONTAINED WITHIN THE PROJECT LIMITS.
- 6. ANY DAMAGED OR INEFFECTIVE ROCK BAGS ARE TO BE REPLACED WITH NEW ONES. THE LOCATION OF ROCK BAGS INSTALLATION IS AS MENTIONED IN THE SWPPP PLANS. THE PROJECT ENGINEER MAY SPECIFY OTHER AREAS AS NECESSARY.
- 7. DITCH BOTTOM INLETS SHALL BE PROTECTED FROM SEDIMENT INTAKE UNTIL PROJECT IS COMPLETE. ELEVATION OF GROUND OUTSIDE INLET TOP SHALL NOT BE HIGHER THAN INLET TOP. ROCK BAGS SHALL BE INSTALLED AROUND INLET TOP. COMPLETED INLETS IN PAVED AREAS SHALL ALSO BE PROTECTED WITH ROCK BAGS TO PREVENT SEDIMENT INTAKE.
- 8. CURB INLETS ALSO SHALL BE PROTECTED FROM SEDIMENT INTAKE UNTIL THE PROJECT IS COMPLETE. ALL EXPOSED SLOPED MATERIAL ADJACENT TO INLET, SHALL BE COVERED WITH EROSION CONTROL MATTING WITH OUTER LIMITS PROTECTED BY ROCK BAGS.
- 9. STOCKPILED MATERIAL SHALL NOT BE LEFT IN EROSION PRONE AREAS UNLESS PROTECTED BY COVER OR ROCK BAGS.
- 10. INSPECTION OF EROSION CONTROL MEASURES AND CONDITION OF ADJACENT PROPERTIES, SHALL BE PERFORMED DAILY BY THE CONTRACTOR'S REPRESENTATIVE AND THE PROJECT ENGINEER. DEFICIENCIES SHALL BE NOTED AND CORRECTED.
- 11. ANY OFFSITE SEDIMENT DISCHARGE TO A MUNICIPAL SEPARATE STORM WATER SYSTEM ARISING FROM THE CONTRACTOR'S ACTIVITIES IS NOT ALLOWED.
- 12. THE USE OF SANITARY SEWERS, FRENCH DRAINS, COVER DITCHES AND/OR ROCK DRAINS FOR THE DISPOSAL OF WASTEWATER IS EXPRESSLY PROHIBITED.

STORM WATER POLLUTION PREVENTION PLAN (SWPPP) **CHECKLIST**

A. SEQUENCE OF SOIL DISTURBING ACTIVITIES AND IMPLEMENTATION OF CONTROLS:

- CLEAR & GRUBBING
- INSTALL DRAINAGE STRUCTURES
- **STABILIZATION**
- BASE PREPARATION
- ASPHALT APPLICATION PLACEMENT OF ROCK BAGS AROUND INLETS
- PLACEMENT OF ROCK BAGS AROUND MANHOLES
- APPLICATION OF FRICTION COURSE A.C.
- INSTALLATION OF STREET SIGNING
- 10. PAVEMENT MARKING
- REMOVE ROCK BAGS 11.
- CLEAN ALL CONSTRUCTION DEBRIS FROM CONSTRUCTION SITE

B. GENERAL

- APPROVED STATE, LOCAL PLANS OR STORM WATER PERMITS.
- ALL OF THE CONTROLS SHALL BE MAINTAINED AT ALL TIMES.
- ALL CONTROLS SHALL BE INSPECTED DAILY.
- APPLY FERTILIZERS AND PESTICIDES ACCORDING TO STANDARD SPECIFICATIONS. DESIGN AND SPECIAL PROVISIONS.
- REPORT NON-STORM WATER DISCHARGE (INCLUDING SPILL) 305) 416-1200.
- VISIT WWW.DEP.STATE.FL.US/WATER/STORMWATER/NPDES/

ESIGNED BY HECKED BY: ATE: 9/25/2023 DATE BY: DESCRIPTION





TOWN HALL 10720 CARIBBEAN BOULEVARD CUTLER BAY, FL 33189 HONF: (305) 234-426

CUTLER RIDGE PINES ROADWAY AND DRAINAGE **IMPROVEMENTS**

STORMWATER POLLUTION PREVENTION PLAN NOTES & DETAILS

AS SHOWN PROJECT NO 2222

DWG. NO.: SHEET